
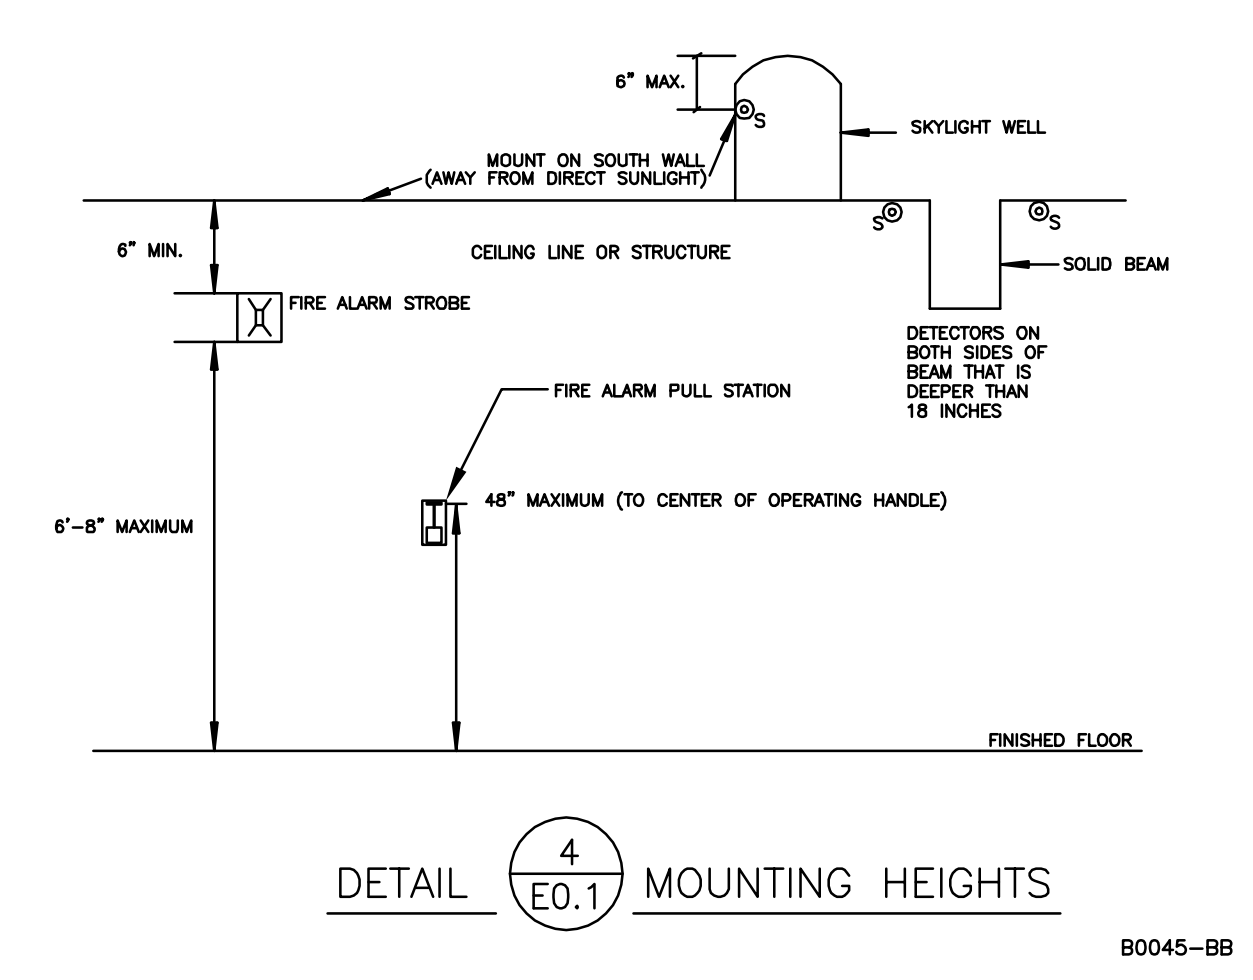
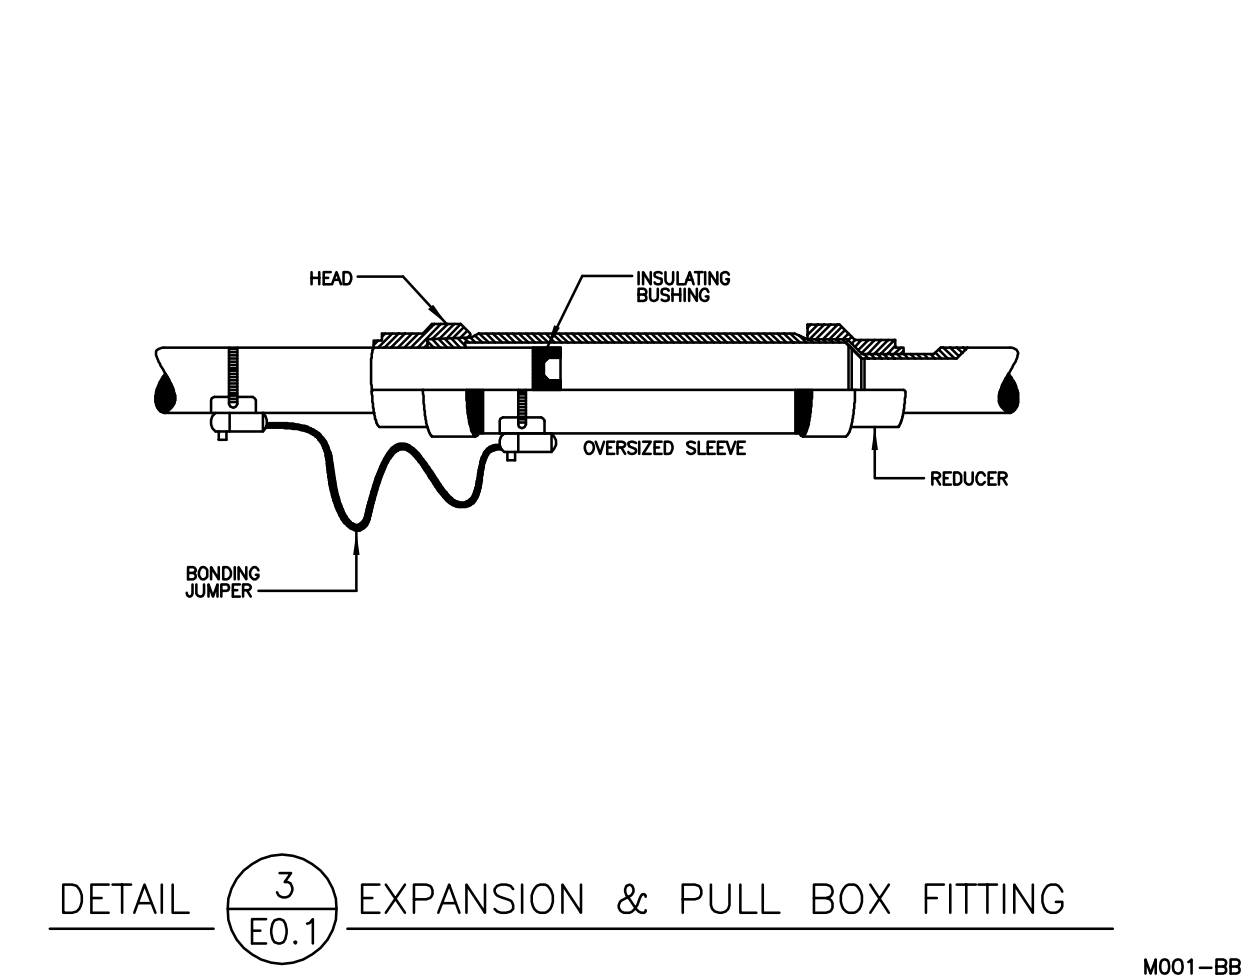
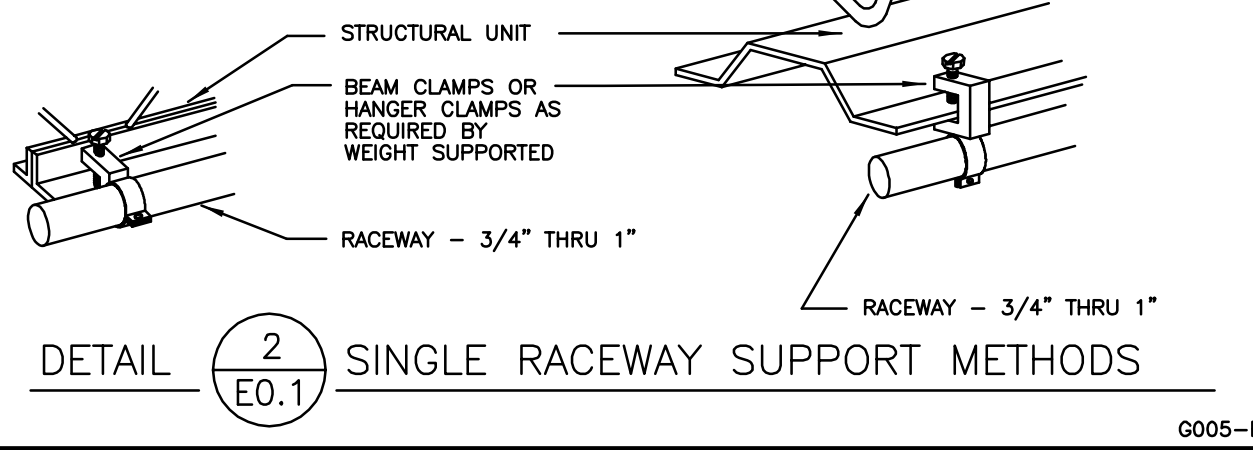


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GENERAL NOTES

- THE INTENT OF THIS PROJECT IS TO UPGRADE THE EXISTING FIRE ALARM AND TO BRING THE SYSTEM UP TO CURRENT CODES AND ADA COMPLIANCE. EXISTING NON-ADDRESSABLE DEVICES SHALL BE REPLACED WITH ADDRESSABLE DEVICES TO CONVERT THE FIRE ALARM SYSTEM FROM A ZONE TYPE TO AN ADDRESSABLE SYSTEM. THE INTENT IS TO LEAVE EXISTING INITIATING ZONE WIRING IN PLACE. ADDRESSABLE ID-NET EXPANSION MODULES SHALL BE PROVIDED AND RETROFITTED TO THE EXISTING FIRE ALARM CONTROL PANEL, WHICH WILL ENABLE THE EXISTING WIRING TO PERFORM AN ADDRESSABLE FUNCTION IN CONJUNCTION WITH THE NEW ADDRESSABLE DEVICES.
- HORN/STROBE INDICATING DEVICES SHALL BE PROVIDED TO REPLACE EXISTING HORNS, AND ADDITIONAL HORN/STROBES SHALL BE PROVIDED TO COMPLY WITH WITH ADA REQUIREMENTS. IN MANY CASES, NEW INDICATING WIRING AND CONDUIT SHALL BE REQUIRED FOR THIS UPGRADE, AND NAC PANELS SHALL BE PROVIDED TO POWER THE INDICATING CIRCUITS.
- NEW CONDUIT SHALL BE RUN CONCEALED WITHIN THE EXISTING ACCESSIBLE CEILINGS AND IN EXISTING PARTITION WALLS.
- IN AREAS WITH NON-ACCESSIBLE CEILINGS OR MASONRY WALLS, NEW CONDUIT SHALL BE RUN SURFACE MOUNTED. THE CONTRACTOR SHALL PAINT ALL CONDUIT TO MATCH THE EXISTING WALL AND CEILING SURFACES. THE CONTRACTOR SHALL PROVIDE ALL MATERIALS AND LABOR TO PENETRATE, CORE DRILL, PATCH, AND REPAIR (AND PAINT) EXISTING CEILINGS AND WALLS FOR THE INSTALLATION OF WORK UNDER THIS CONTRACT.
- ALL EXISTING WALLS EXTEND CONTINUOUS ABOVE CEILINGS TO STRUCTURE. INSTALLATION OF NEW CONDUIT WILL REQUIRE PENETRATIONS THROUGH EXISTING WALLS. THE CONTRACTOR SHALL PROVIDE ALL CORE DRILLING AND SEALING OF PENETRATIONS AS REQUIRED.
- VERIFY ALL EQUIPMENT DIMENSIONS AND LOCATIONS BEFORE BEGINNING ROUGH IN. CONSULT ALL APPLICABLE CONTRACT DRAWINGS AND SHOP DRAWINGS TO INSURE NEC CODE CLEARANCES REQUIRED AROUND ALL ELECTRICAL EQUIPMENT.
- CONTRACTOR SHALL VERIFY ALL ELECTRICAL LOADS (VOLTAGE, PHASE, CONNECTION REQUIREMENTS, ETC.) OF ALL EQUIPMENT WITH APPROVED SHOP DRAWINGS BEFORE BEGINNING ROUGH IN.
- SEE APPLICABLE SHOP DRAWINGS FOR ROUGH IN LOCATION OF ALL EQUIPMENT, WIRING DEVICES, ETC. WHERE APPLICABLE MOUNT ALL WIRING DEVICES ABOVE BACK SPLASH EXCEPT THOSE SERVING UNDER COUNTER EQUIPMENT. LOCATE DEVICES AS REQUIRED TO AVOID BEING HIDDEN BEHIND OR ENCOMBERED BY CABINETS, MILLWORK, ETC.
- ELECTRICAL BOXES SHALL NOT BE LOCATED IN MASONRY COLUMNS IN BRICK WALLS OR IN GROUDED CELLS ADJACENT TO OPENINGS. COORDINATE LOCATION OF BOXES WITH MASONRY CONTRACTOR.
- ALL PENETRATIONS OF FIRE RATED FLOORS, WALLS, AND CEILINGS SHALL BE SEALED WITH APPROVED MATERIAL TO MAINTAIN FIRE RATING OF SURFACE PENETRATED.
- CIRCUITS EXTENDING OVER 70' FOR 120 VOLT AND 165' FOR 277 VOLT 20 AMP CIRCUITS SHALL BE RUN WITH MINIMUM #10 CONDUCTORS.

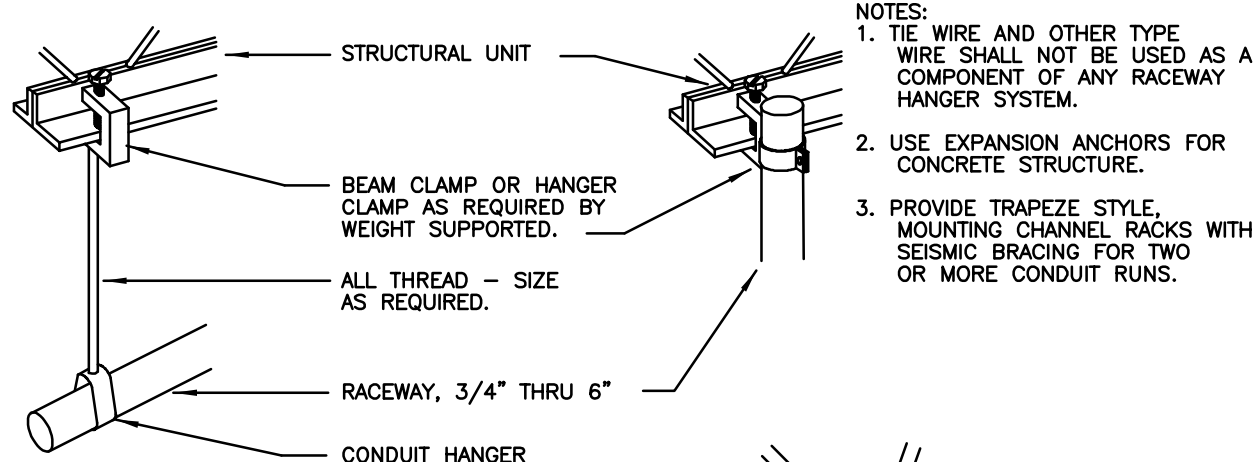

ELECTRICAL SYMBOL SCHEDULE

STANDARD MOUNTING HEIGHT UNLESS OTHERWISE NOTED ON PLANS			
SYMBOL	DESCRIPTION	MOUNTING HEIGHT	NOTES
→	ONE CIRCUIT, TWO WIRE HOME RUN TO PANEL		
→→	2 CIRCUIT, 3 WIRE, COMMON NEUTRAL HOME RUN		
→→→	3 CIRCUIT, 4 WIRE, COMMON NEUTRAL HOME RUN		
----	CONDUIT RUN CONCEALED IN WALL OR CEILING		
----	CONDUIT RUN CONCEALED IN FLOOR OR GROUND		
○	CONDUIT UP		
●	CONDUIT DOWN		
—○—	CONDUIT STUB LOCATION	CAR CONDUIT	
○	CEILING LIGHT FIXTURE	CEILING	1.
○	WALL LIGHT FIXTURE	AS NOTED	1.
○	RECESSED DOWNLIGHT FIXTURE	CEILING	1.
○	FLUORESCENT LIGHT FIXTURE	AS NOTED	1
○	FLUORESCENT EGRESS LIGHT FIXTURE	AS NOTED	UNSWITCHED
⊗	CEILING MOUNTED EXIT LIGHT	CEILING	1.3.8.
⊗	WALL MOUNTED EXIT LIGHT	AS NOTED	1.3.8.
\$	SINGLE POLE SWITCH	+4'-0"	2.
\$°	SINGLE POLE SWITCH	+4'-0"	4. 2.
\$3	THREE-WAY SWITCH	+4'-0"	2.
\$4	FOUR-WAY SWITCH	+4'-0"	2.
\$K	KEY OPERATED SWITCH	+4'-0"	2.
\$P	SWITCH WITH PILOT LIGHT	+4'-0"	2.
\$D	VARIABLE INTENSITY SWITCH	+4'-0"	2.
\$TM	TIMER SWITCH	+4'-0"	2.
⏏	LOW VOLTAGE TRANSFORMER		
⏏	DUPLEX RECEPTACLE	+16" OR AS NOTED	9. 11.
⏏WP	WEATHERPROOF RECEPTACLE	+24" OR AS NOTED	2. 9.
⏏	GROUND FAULT INTERRUPTER DUPLEX RECEPTACLE	+16" OR AS NOTED	9. 11.
⏏	TELEVISION OUTLET (MATV)	+16" OR AS NOTED	11.
⏏	TELEPHONE OUTLET	+16" OR AS NOTED	9. 11.
⏏	CALL SWITCH	+4'-0"	2.
⏏	CLOCK OUTLET	+7'-6"	8.
⏏	CLOCK/SPEAKER COMBINATION	+7'-6"	
⊙1	TYPE 1 SPEAKER (SECURITY TYPE)		
⊙2	TYPE 2 SPEAKER (RECESSED)	WALL/CLG	
⏏M	INTERCOM MASTER TELEPHONE		
⏏	JUNCTION BOX (1" IN FLOOR)	AS NOTED	
⏏	PANEL BOARD	TOP AT +6'-0"	
⏏	MAIN DISTRIBUTION PANEL		
⏏	TELEPHONE TERMINAL BOARD		
⏏	BELL	+7'-6"	
⏏	FIRE ALARM MANUAL STATION	+4'-0"	2.
⏏	FIRE ALARM SIGNAL HORN/STROBE PROJECTORS	+6'-8"	6.
⏏	FIRE ALARM SIGNAL HORN/STROBE	+6'-8"	6.
⊙D	SMOKE DETECTOR	CEILING	
⊙D	DUCT SMOKE DETECTOR	AS NOTED	MTD. IN DUCT
⊙H	HEAT DETECTOR	CEILING	
⏏---	FIRE/SMOKE DAMPER		
⏏	DOOR HOLDER	AS NOTED	
⏏	FLOW SWITCH		
⏏	TAMPER SWITCH		
⏏	WATER FLOOD INDICATOR		
⏏	O.S. & Y. VALVE/SPRINKLER RISER		SEE DIAGRAM
⏏	FIRE ALARM RELAY		
⏏M	FIRE ALARM CONTROL MODULE		
⏏M	FIRE ALARM MONITOR MODULE		
⏏	FIRE ALARM STROBE	+6'-8"	6.
⏏	DURESS PUSHBUTTON	+4'-0"	
⏏1	SECURITY SYSTEM DOOR SWITCH	DOOR JAMB	
⏏2	SECURITY SYSTEM OVERHEAD DOOR SWITCH	CEILING	MOUNT AS PER. MAN
⏏	MAGNETIC SHEAR LOCK		
⏏	SECURITY MOTION DETECTOR		MOUNT AS PER. MAN
⏏	ELECTRIC DOOR LOCK		
⏏	ACCESS CONTROL CARD READER	+4'-0"	2.
⏏	CLOSED CIRCUIT TELEVISION CAMERA	AS NOTED	
⏏	DOOR POSITION INDICATING SWITCH		
⏏	ARCHITECTURAL ROOM NUMBER		
⏏	LIGHT FIXTURE (LETTER DESIGNATES TYPE)		
⏏	EQUIPMENT NUMBER		

MARK	DATE	DESCRIPTION
△		

DATE:	FEBRUARY 22, 2006
PROJECT NO:	05339A
DRAWN BY:	BNA
CHK'D BY:	GM

SYMBOLS,  
SCHEDULES  
AND NOTES

DATE:	FEBRUARY 22, 2006
PROJECT NO:	05339A
DRAWN BY:	BNA
CHK'D BY:	GM

**E0-2**



By: sharon Feb 22, 2006 - 10:19am  
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GENERAL NOTES

1. EXISTING CONDUITS FOR FIRE ALARM WIRING TO HOUSING UNIT D ARE PER EXISTING DESIGN DRAWINGS RELATED TO WORK PERFORMED IN 1991, AND IS SHOWN FOR REFERENCE. THE ACTUAL ROUTINE MAY DIFFER.

SHEET KEYNOTES

1 (3) EXISTING 3/4" CONDUITS FROM HOUSING UNITS TO THE EXISTING FIRE ALARM CONTROL PANEL LOCATED IN THE ADMINISTRATION BUILDING. CONDUITS CONTAIN WIRING FOR FIRE ALARM AND DURESS ZONE.

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DEPARTMENT OF SOCIAL SERVICES  
ADDRESS

ADDENDUM/CLARIFICATION/REVISION		
MARK	DATE	DESCRIPTION
△	.	

DATE: FEBRUARY 22, 2006  
PROJECT NO: 05339A  
DRAWN BY: BNA  
CHK'D BY: GM

PROJECT  
SITE PLAN

E1-1

PLAN  
NORTH

PROJECT SITE PLAN

1" = 40'

0 20' 40' 80'



## GENERAL SHEET NOTES

1. ALL EXISTING NON-ADDRESSABLE SMOKE DETECTORS SHALL BE REMOVED. PROVIDE NEW ADDRESSABLE SMOKE DETECTORS. REFER TO SHEETS E4-1, E4-2, E4-3, E4-4, AND E4-5 FOR NEW DEVICE LOCATIONS.
2. ALL EXISTING NON-ADDRESSABLE MANUAL PULL STATION SHALL BE REMOVED. PROVIDE NEW ADDRESSABLE PULL STATIONS. REFER TO SHEETS E4-1, E4-2, E4-3, E4-4, AND E4-5 FOR NEW DEVICE LOCATIONS.
3. ALL EXISTING FIRE ALARM HORNS SHALL BE REMOVED. PROVIDE NEW HORN/STROBES REFER TO SHEETS E4-1, E4-2, E4-3, E4-4, AND E4-5 FOR NEW DEVICES.
4. THE EXISTING INITIATING DEVICE LOOP WIRING SHALL REMAIN AS-IS WITH NO MODIFICATIONS.

## SHEET KEYNOTES

- ① REMOVE EXISTING DEVICE AND REWIRE TO BYPASS THIS DEVICE. PROVIDE BLANK COVER, PAINT TO MATCH EXISTING SURFACE.



ADMINISTRATION BLDG.  
DEMOLITION PLAN - AREA A

SCALE: 1/8" = 1'-0"

0 4' 8' 16'

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SECURE RESIDENTIAL FACILITY  
FOR THE DIVISION OF YOUTH CORRECTIONS  
DEPARTMENT OF SOCIAL SERVICES  
ADDRESS

ADDENDUM/CLARIFICATION/REVISION		
MARK	DATE	DESCRIPTION

DATE: FEBRUARY 22, 2006  
PROJECT NO: 05339A  
DRAWN BY: BNA  
CHK'D BY: GM

DEMOLITION  
PLAN, AREA A

E2-1

## GENERAL SHEET NOTES

1. ALL EXISTING NON-ADDRESSABLE SMOKE DETECTORS SHALL BE REMOVED. PROVIDE NEW ADDRESSABLE SMOKE DETECTORS. REFER TO SHEETS E4-1, E4-2, E4-3, E4-4, AND E4-5 FOR NEW DEVICE LOCATIONS.
2. ALL EXISTING NON-ADDRESSABLE MANUAL PULL STATION SHALL BE REMOVED. PROVIDE NEW ADDRESSABLE PULL STATIONS. REFER TO SHEETS E4-1, E4-2, E4-3, E4-4, AND E4-5 FOR NEW DEVICE LOCATIONS.
3. ALL EXISTING FIRE ALARM HORNS SHALL BE REMOVED. PROVIDE NEW HORN/STROBES REFER TO SHEETS E4-1, E4-2, E4-3, E4-4, AND E4-5 FOR NEW DEVICE LOCATIONS.
4. THE EXISTING INITIATING DEVICE LOOP WIRING SHALL REMAIN AS IS WITH NO MODIFICATIONS.

## SHEET KEYNOTES

- ① REMOVE EXISTING DEVICE AND REWIRE TO BYPASS THIS DEVICE. PROVIDE BLANK COVER, PAINT TO MATCH EXISTING SURFACE.



PLAN NORTH  
HOUSING UNIT DEMOLITION PLAN  
AREA B  
1/8" = 1'-0"

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SECURE RESIDENTIAL FACILITY  
FOR THE DIVISION OF YOUTH CORRECTIONS  
DEPARTMENT OF SOCIAL SERVICES  
ADDRESS


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DATE: FEBRUARY 22, 2006  
PROJECT NO: 05339A  
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DEMOLITION  
PLAN, AREA B

E2-2





PLAN NORTH  
ADMINISTRATION BUILDING  
DEMOLITION PLAN--AREA C  
1/8" = 1'-0"  
0 4' 8' 16'
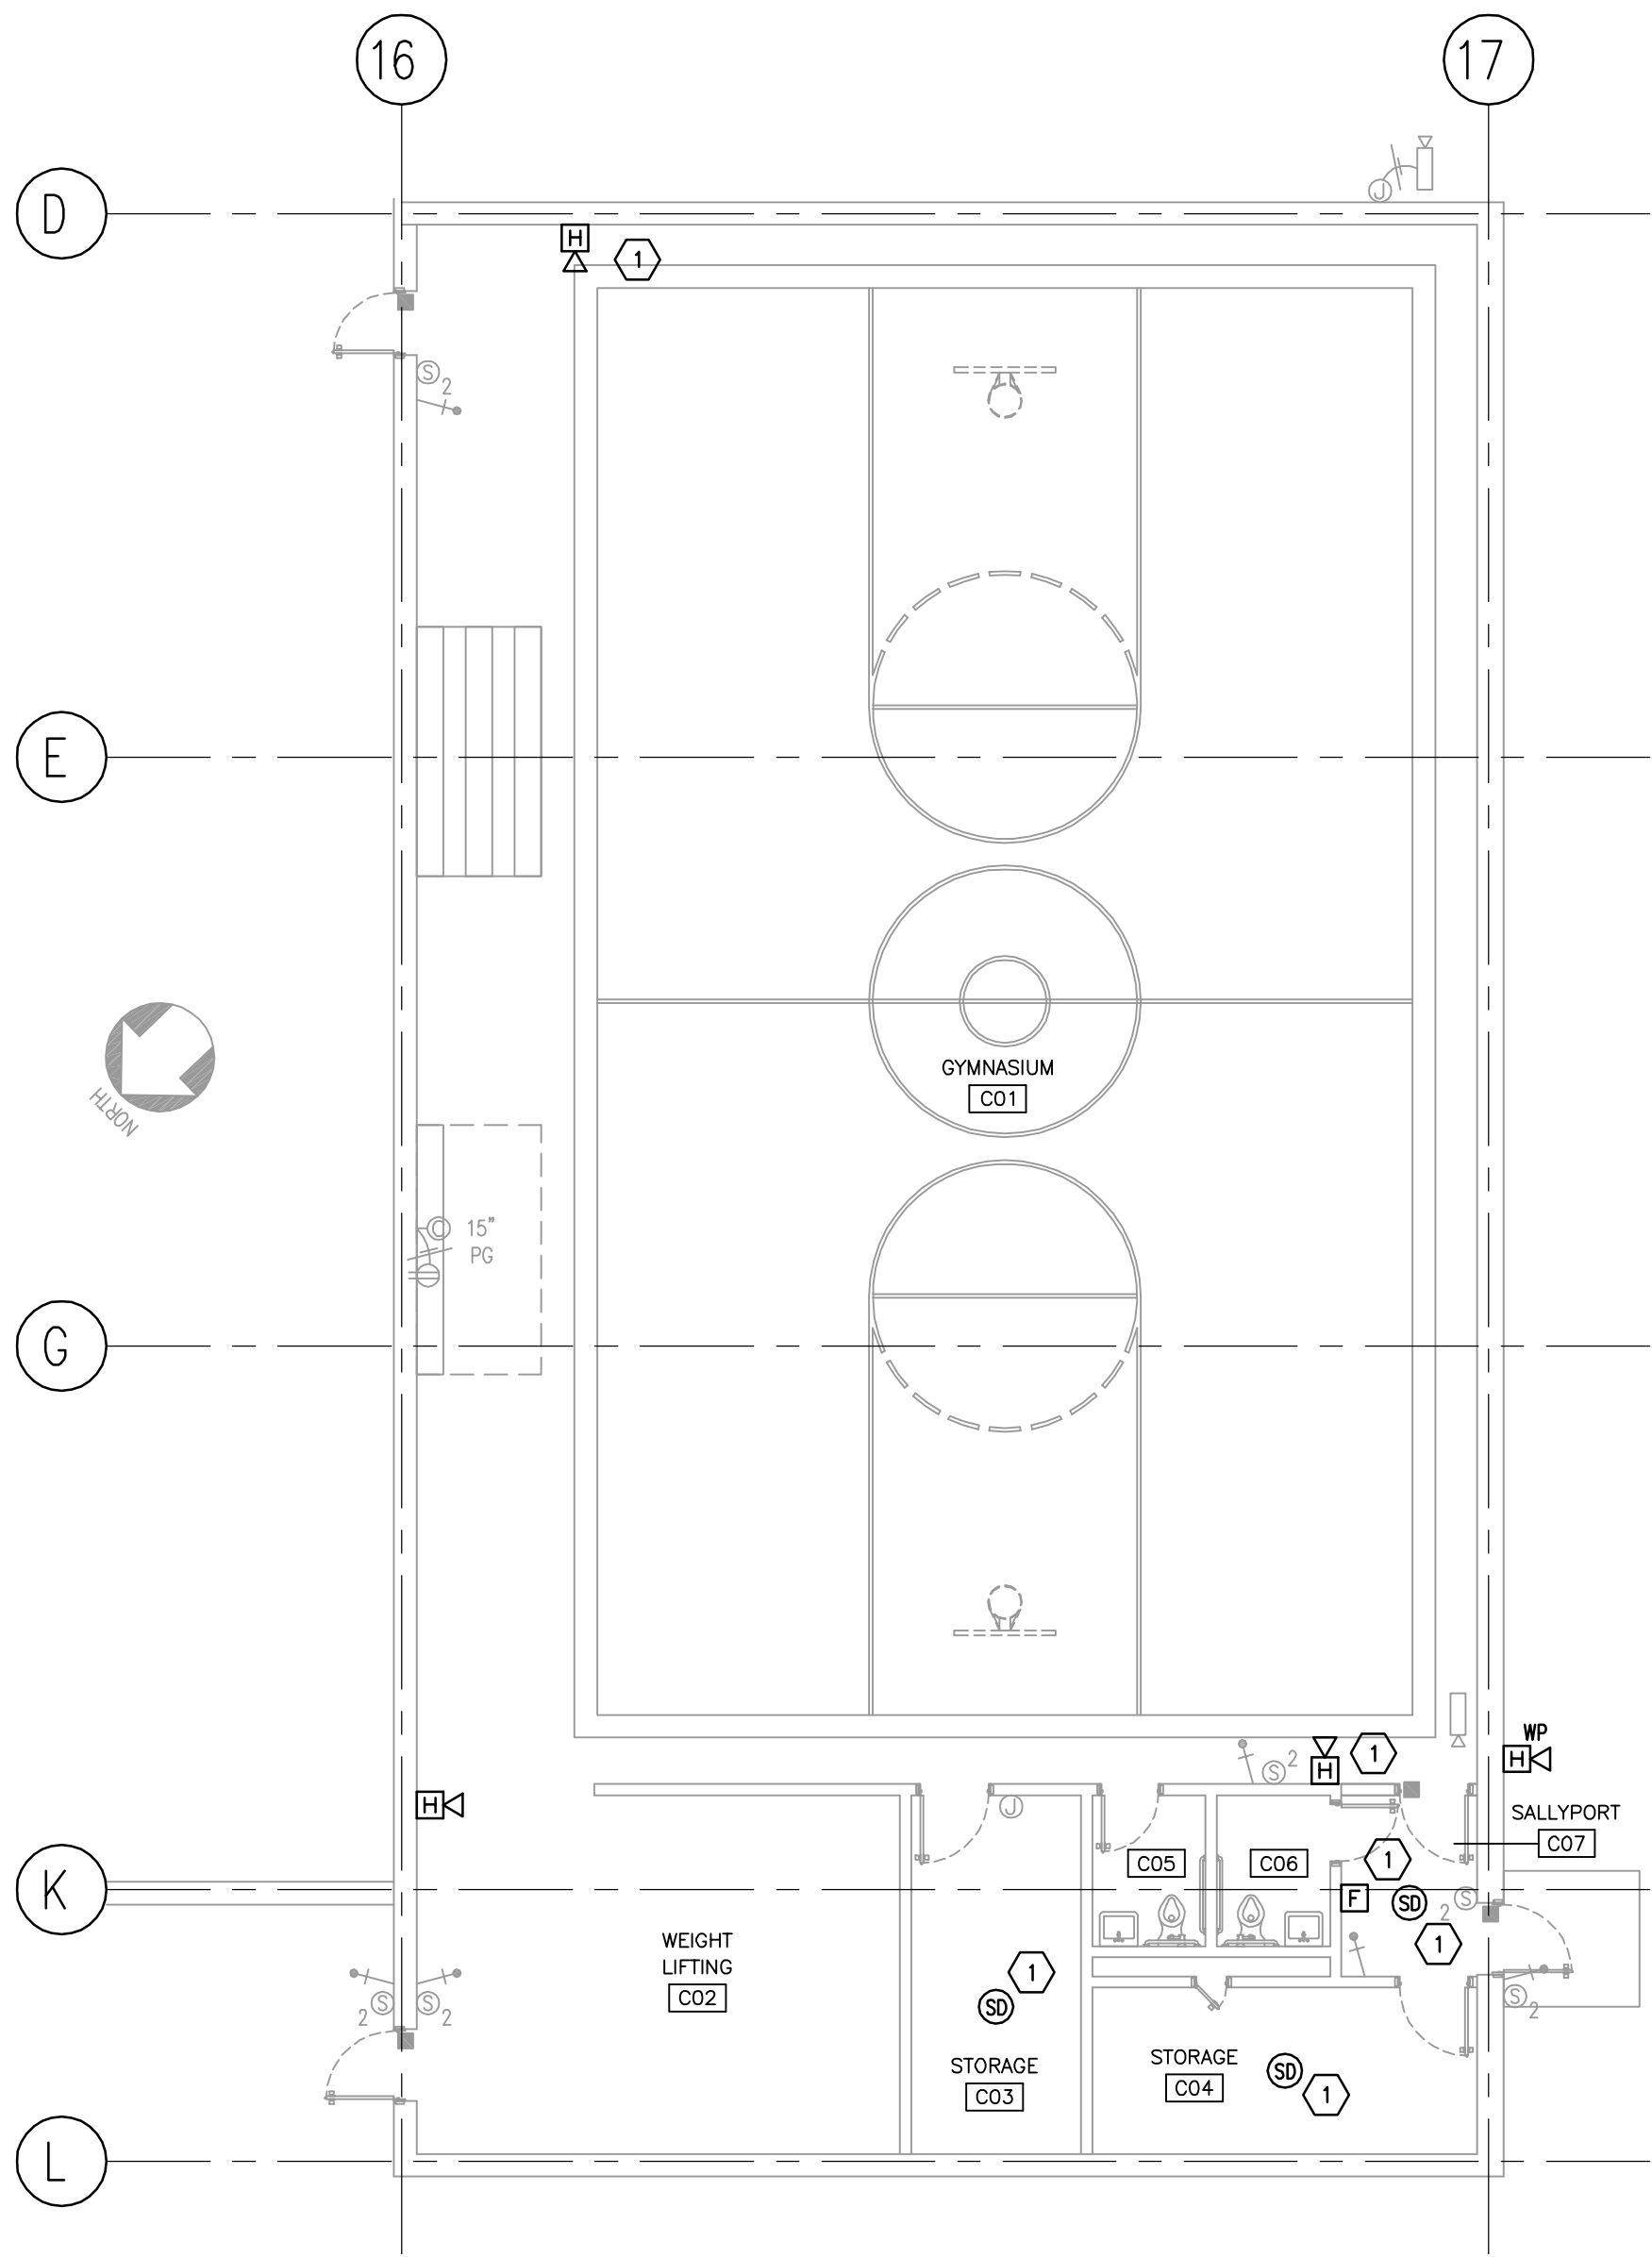
### GENERAL SHEET NOTES

1. ALL EXISTING NON-ADDRESSABLE SMOKE DETECTORS SHALL BE REMOVED. PROVIDE NEW ADDRESSABLE SMOKE DETECTORS. REFER TO SHEETS E4-1, E4-2, E4-3, E4-4, AND E4-5 FOR NEW DEVICE LOCATIONS.
2. ALL EXISTING NON-ADDRESSABLE MANUAL PULL STATION SHALL BE REMOVED. PROVIDE NEW ADDRESSABLE PULL STATIONS. REFER TO SHEETS E4-1, E4-2, E4-3, E4-4, AND E4-5 FOR NEW DEVICE LOCATIONS.
3. ALL EXISTING FIRE ALARM HORNS SHALL BE REMOVED. PROVIDE NEW HORN/STROBES REFER TO SHEETS E4-1, E4-2, E4-3, E4-4, AND E4-5 FOR NEW DEVICE LOCATIONS.
4. THE EXISTING INITIATING DEVICE LOOP WIRING SHALL REMAIN AS-IS WITH NO MODIFICATIONS.


### SHEET KEYNOTES

- ① REMOVE EXISTING DEVICE AND REWIRE TO BYPASS THIS DEVICE. PROVIDE BLANK COVER PAINT TO MATCH EXISTING SURFACE.

ADDENDUM/CLARIFICATION/REVISION		
MARK	DATE	DESCRIPTION
△	.	

DATE: FEBRUARY 22, 2006  
PROJECT NO: 05339A  
DRAWN BY: BNA  
CHK'D BY: GM

DEMOLITION  
PLAN, AREA C

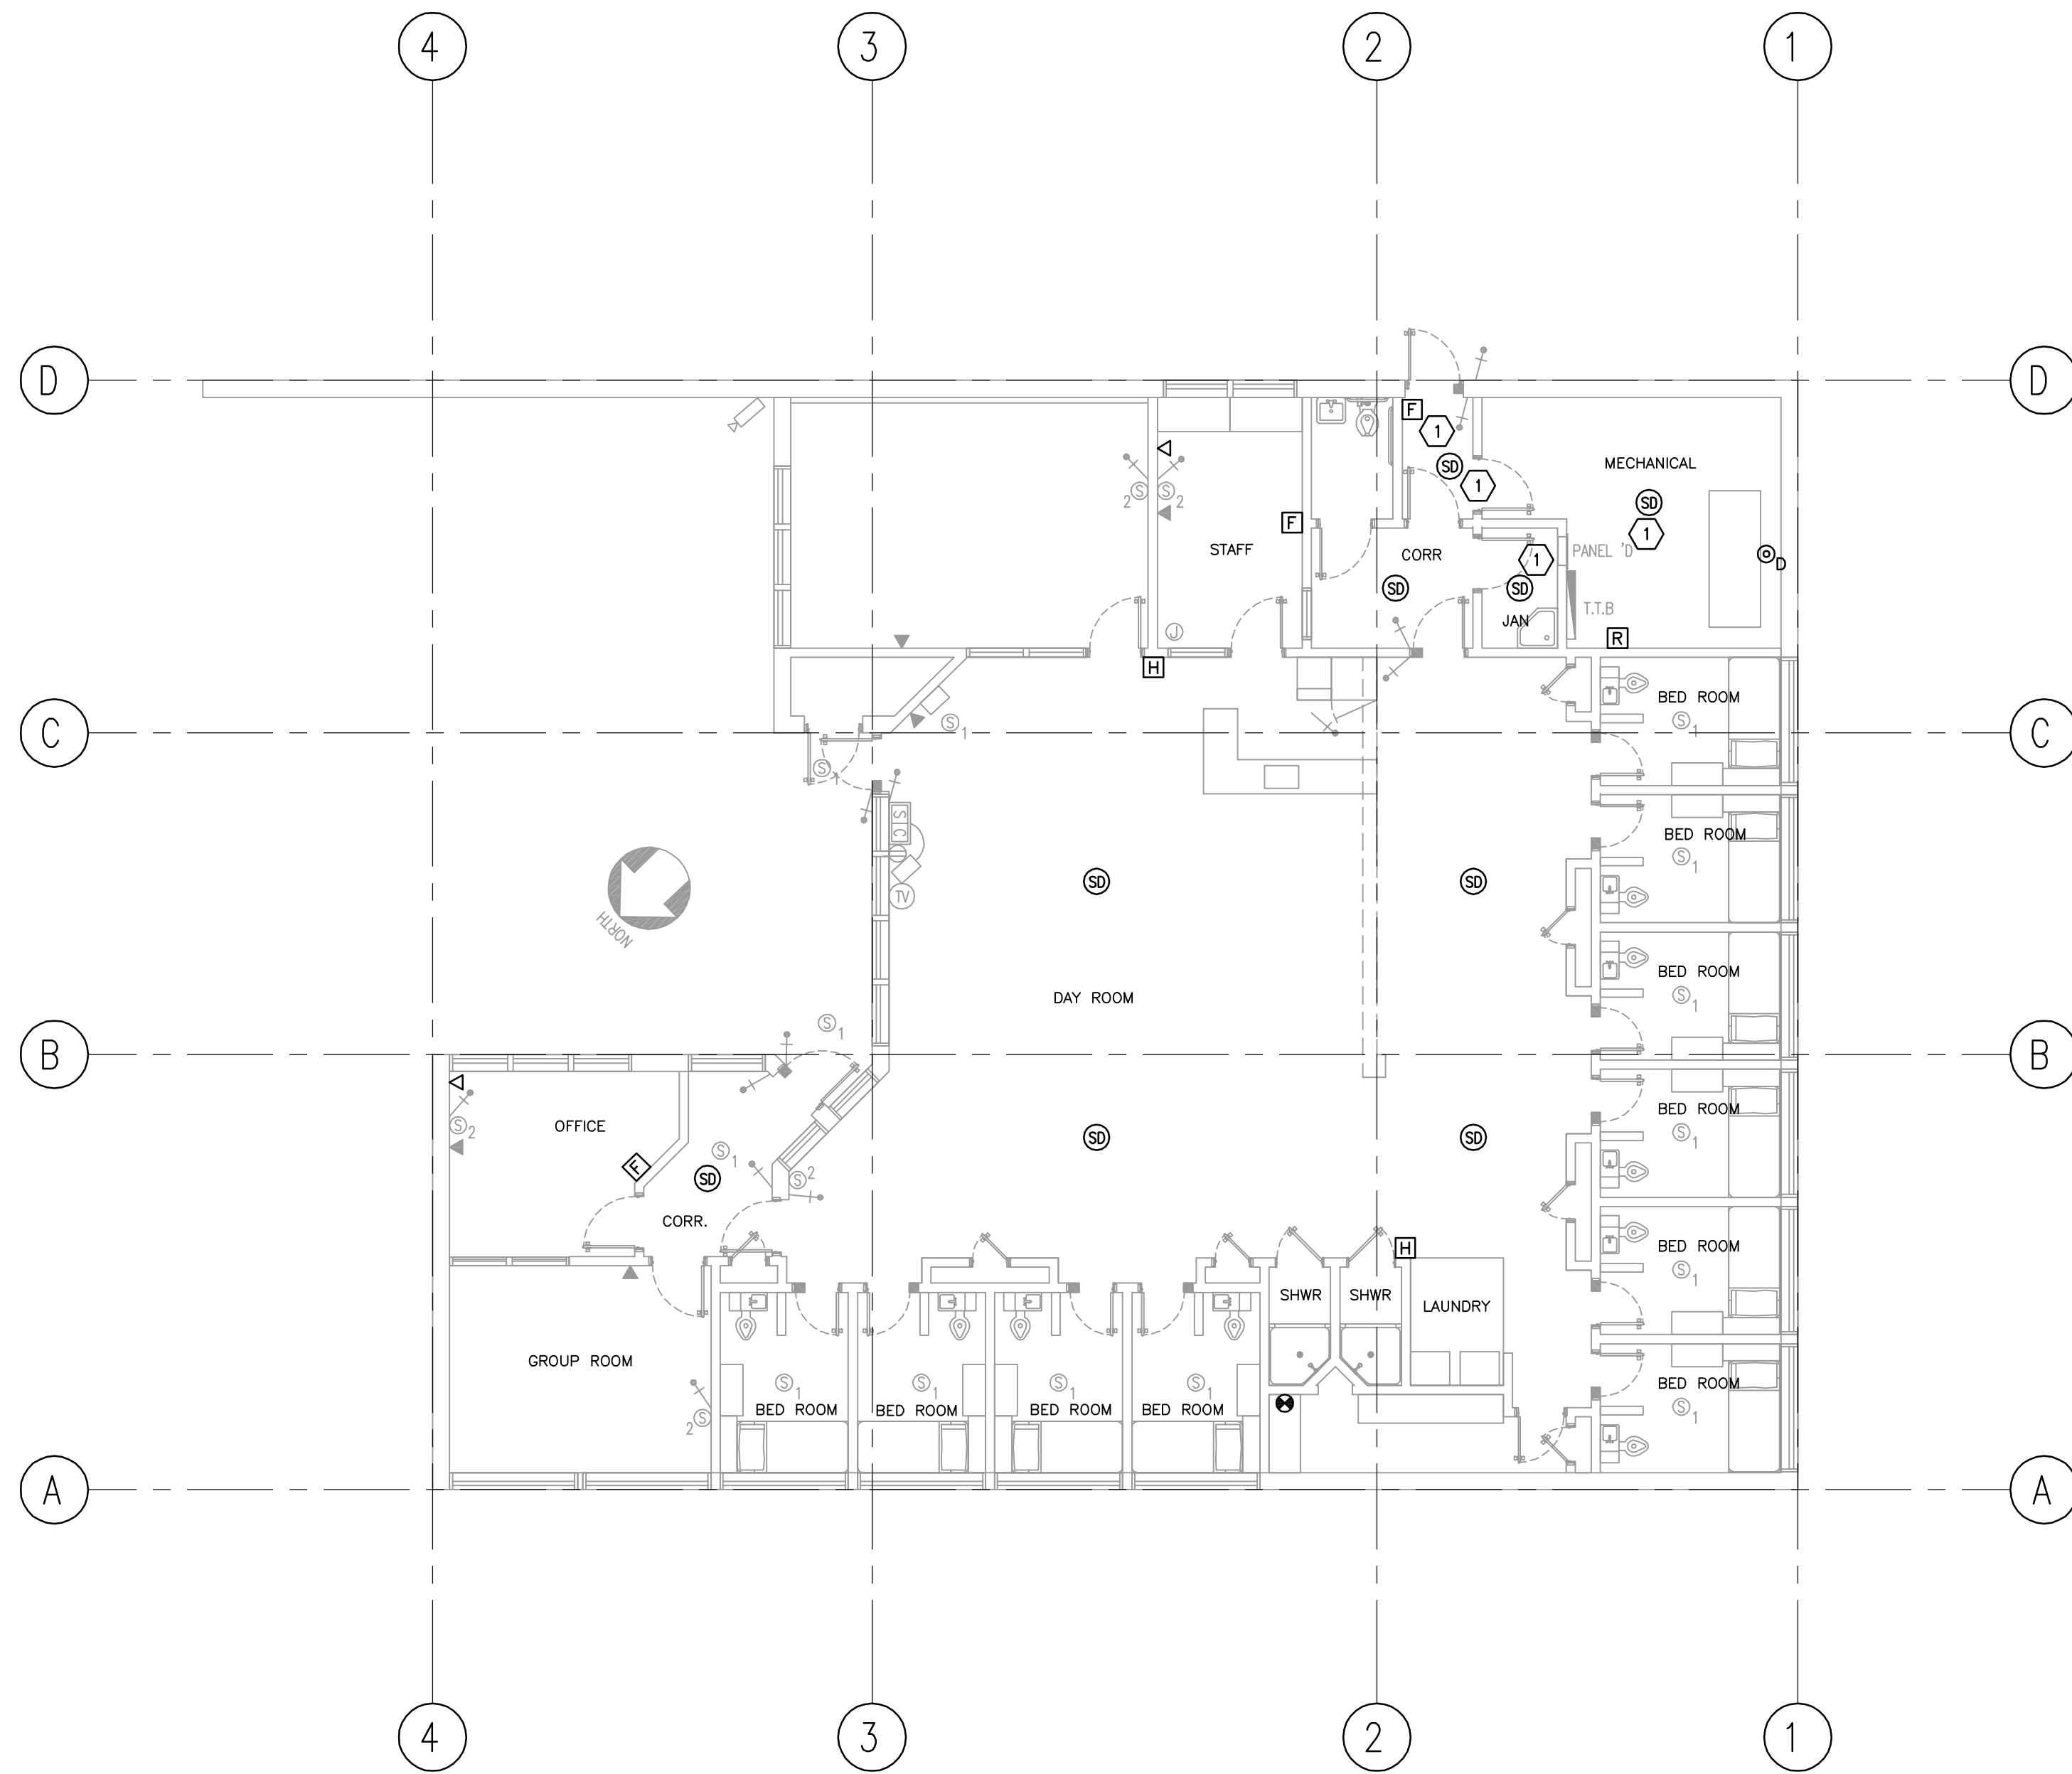

PLAN NORTH  
HOUSING UNIT D-DEMOLITION PLAN  
SCALE: 1/8" = 1'-0"  
0 4' 8' 16'

### GENERAL SHEET NOTES

1. ALL EXISTING NON-ADDRESSABLE SMOKE DETECTORS SHALL BE REMOVED. PROVIDE NEW ADDRESSABLE SMOKE DETECTORS. REFER TO SHEETS E4-1, E4-2, E4-3, E4-4, AND E4-5 FOR NEW DEVICE LOCATIONS.
2. ALL EXISTING NON-ADDRESSABLE MANUAL PULL STATION SHALL BE REMOVED. PROVIDE NEW ADDRESSABLE PULL STATIONS. REFER TO SHEETS E4-1, E4-2, E4-3, E4-4, AND E4-5 FOR NEW DEVICE LOCATIONS.
3. ALL EXISTING FIRE ALARM HORNS SHALL BE REMOVED. PROVIDE NEW HORN/STROBES REFER TO SHEETS E4-1, E4-2, E4-3, E4-4, AND E4-5 FOR NEW DEVICE LOCATIONS.
4. THE EXISTING INITIATING DEVICE LOOP WIRING SHALL REMAIN AS-IS WITH NO MODIFICATIONS.

### SHEET KEYNOTES

- ① REMOVE EXISTING DEVICES AND REWIRE TO BYPASS THIS DEVICE. PROVIDE BLANK COVER, PAINT TO MATCH EXISTING SURFACE.

MARK	DATE	DESCRIPTION
△	.	

DATE: FEBRUARY 22, 2006  
PROJECT NO: 05339A  
DRAWN BY: BNA  
CHK'D BY: GM

DEMOLITION  
PLAN,  
HOUSING  
UNIT D

ADDENDUM/CLARIFICATION/REVISION		
MARK	DATE	DESCRIPTION





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PROJECT NO: 05339A  
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CHK'D BY: GM

ELECTRICAL  
SCHEMATICS

E3-1


## GENERAL NOTES

- INTERCONNECTING CONDUIT RUNS SHOWN ON THIS DRAWING ARE PER EXISTING RECORD DRAWINGS AND MAY NOT BE ENTIRELY ACCURATE. CONTRACTOR SHALL FIELD VERIFY EXISTING CONDUIT RUNS WHERE CONNECTION AND TIE-IN OF NEW DEVICES AND EQUIPMENT TO THE EXISTING WIRING IS PROVIDED.

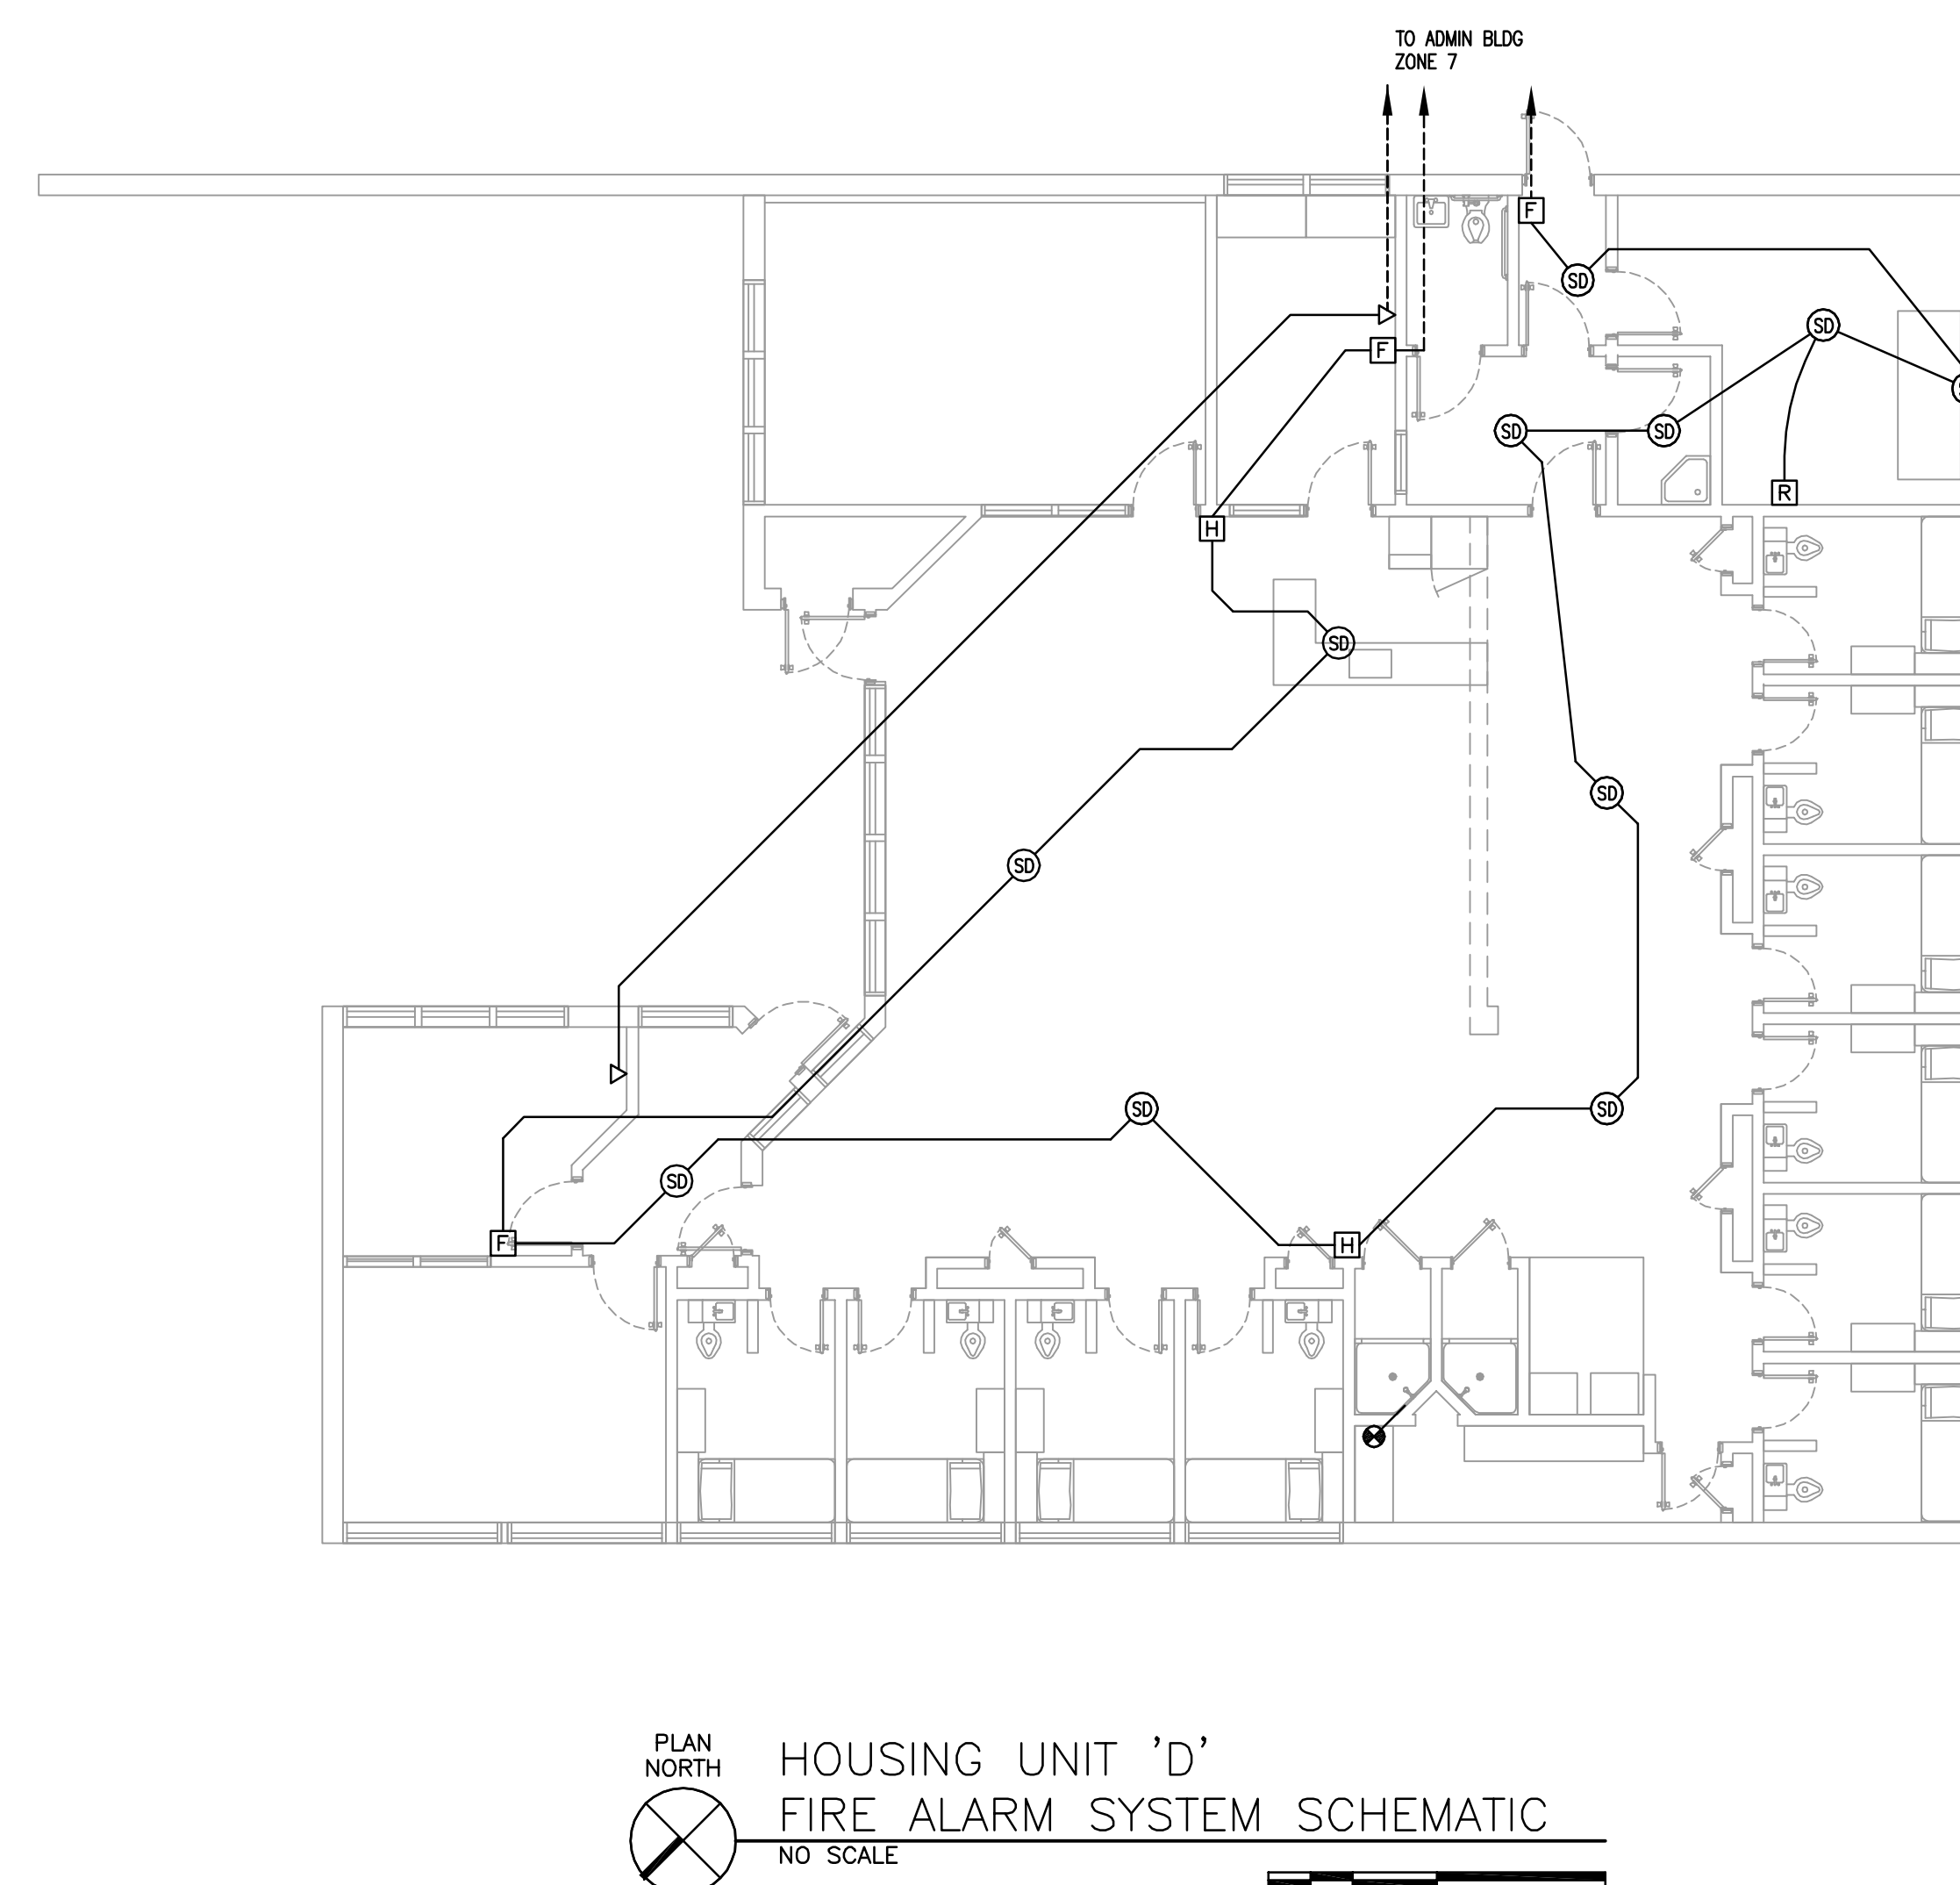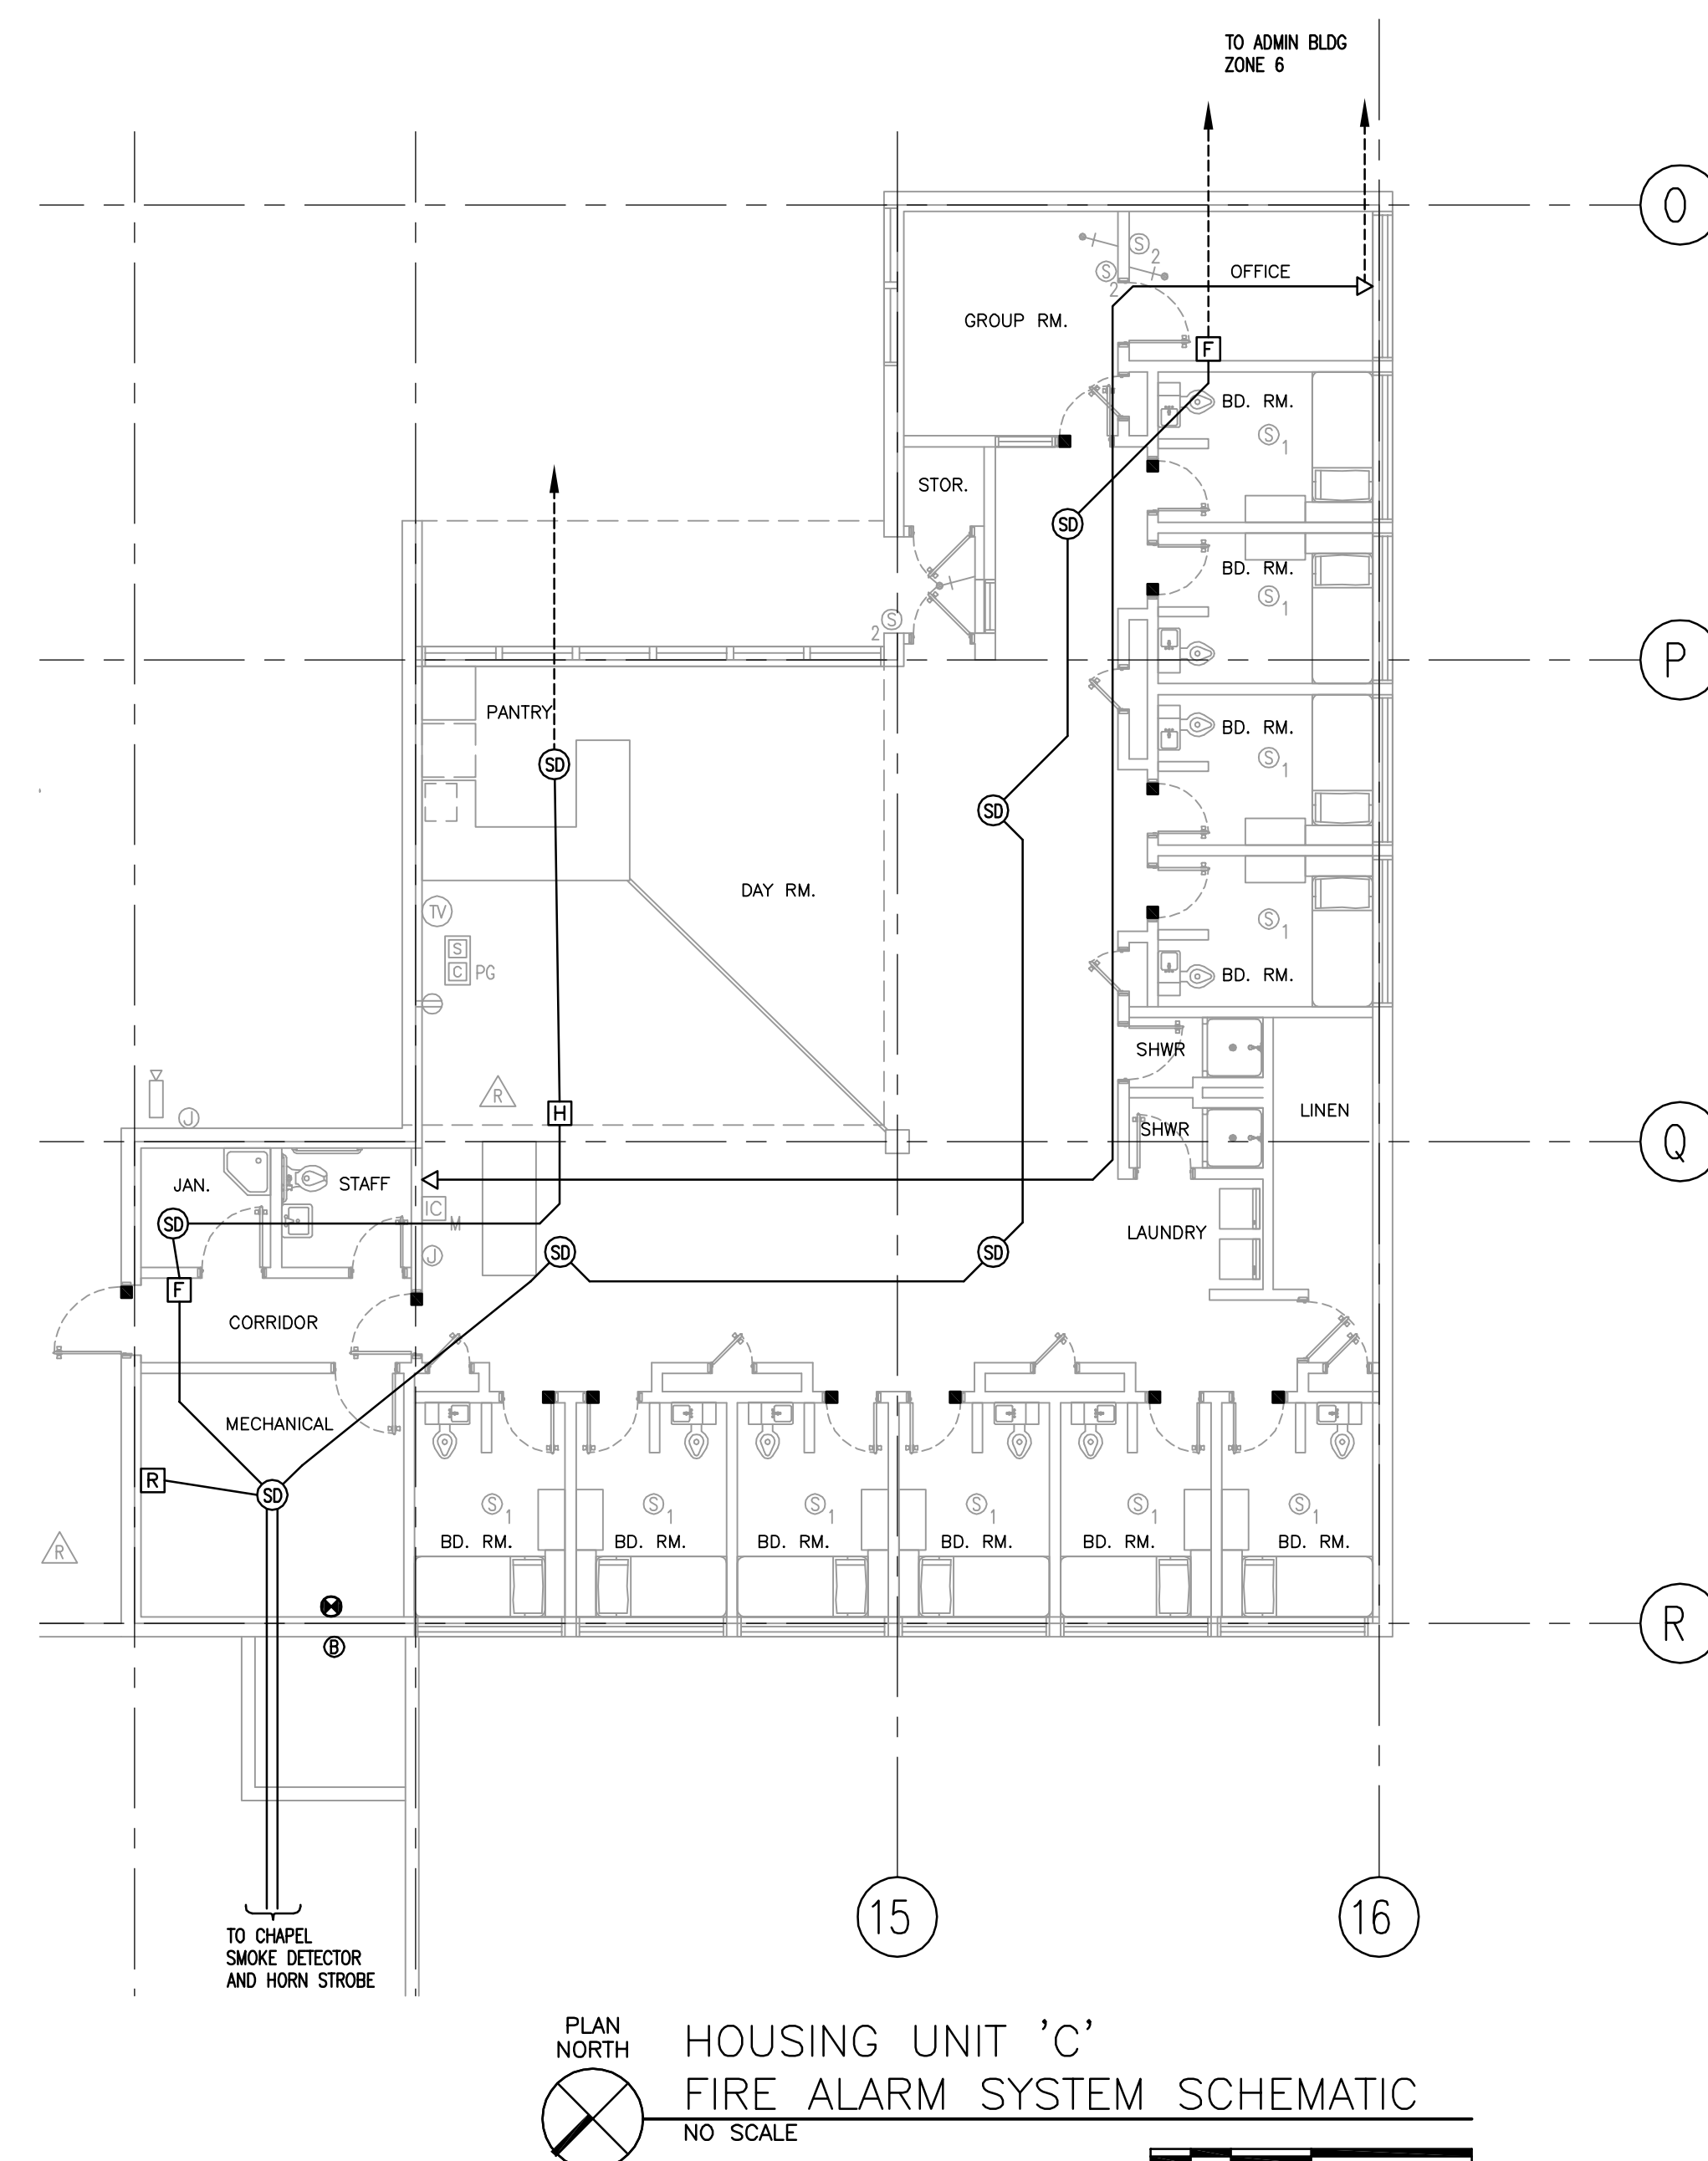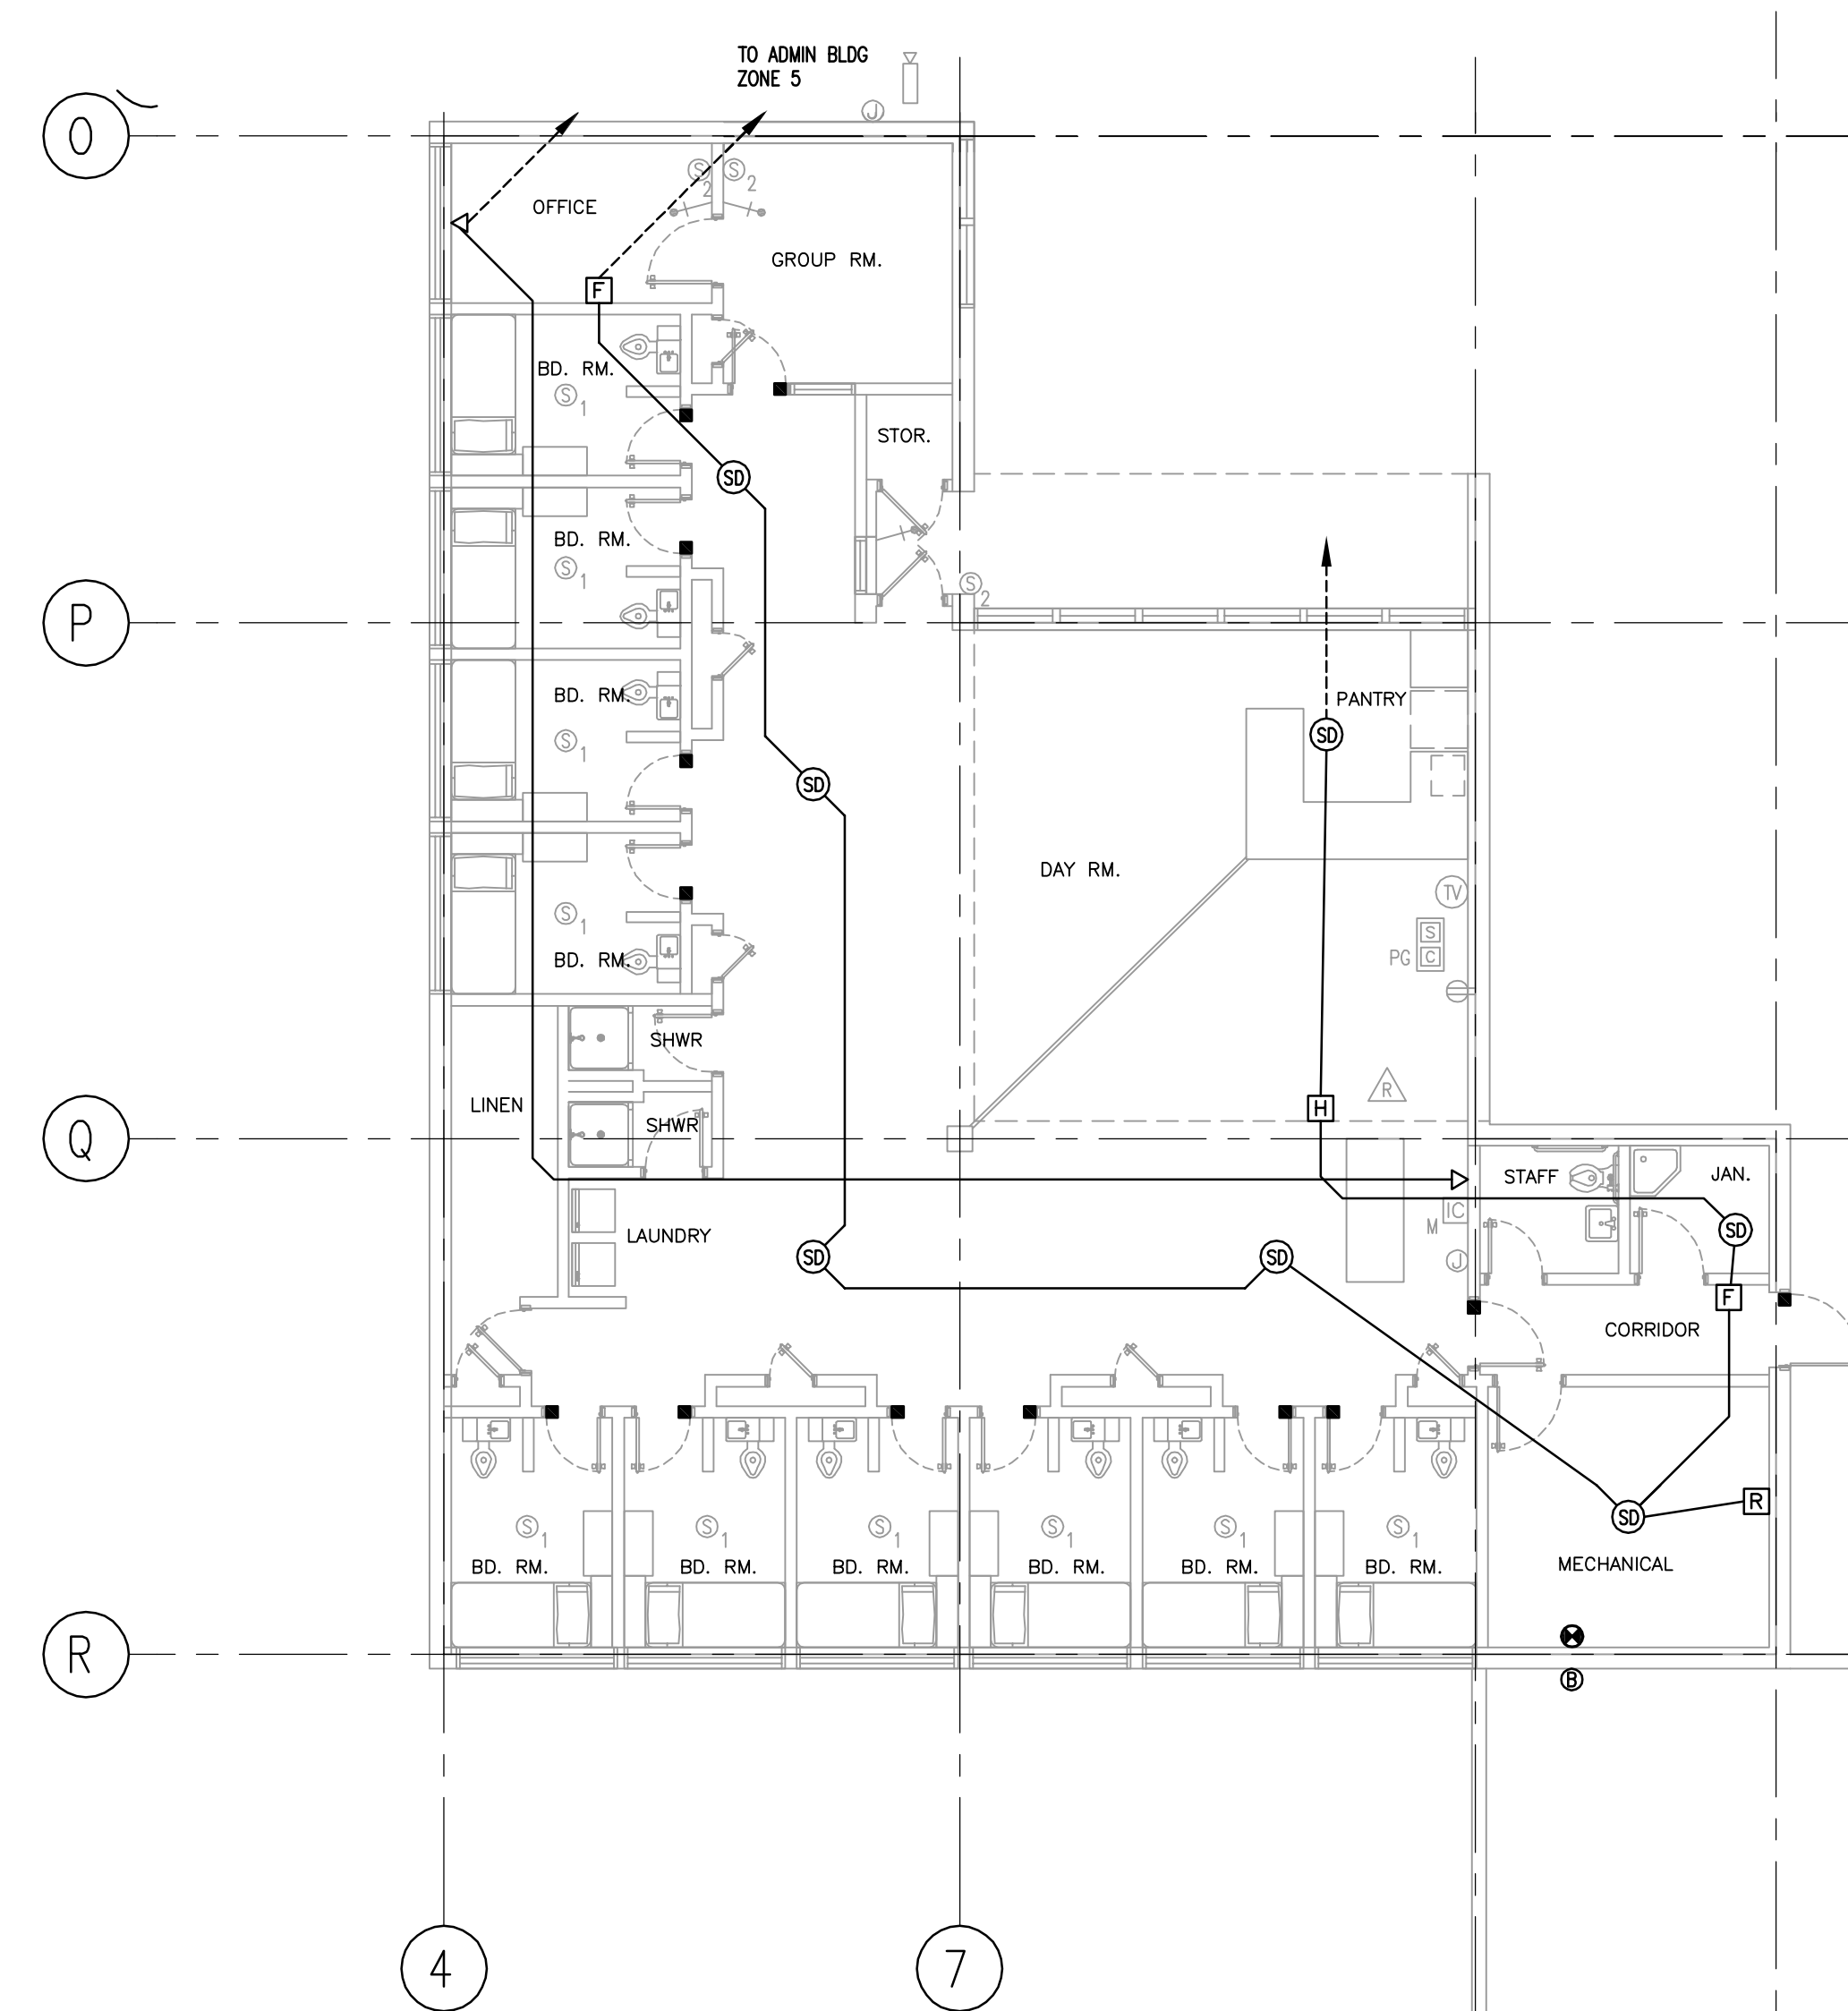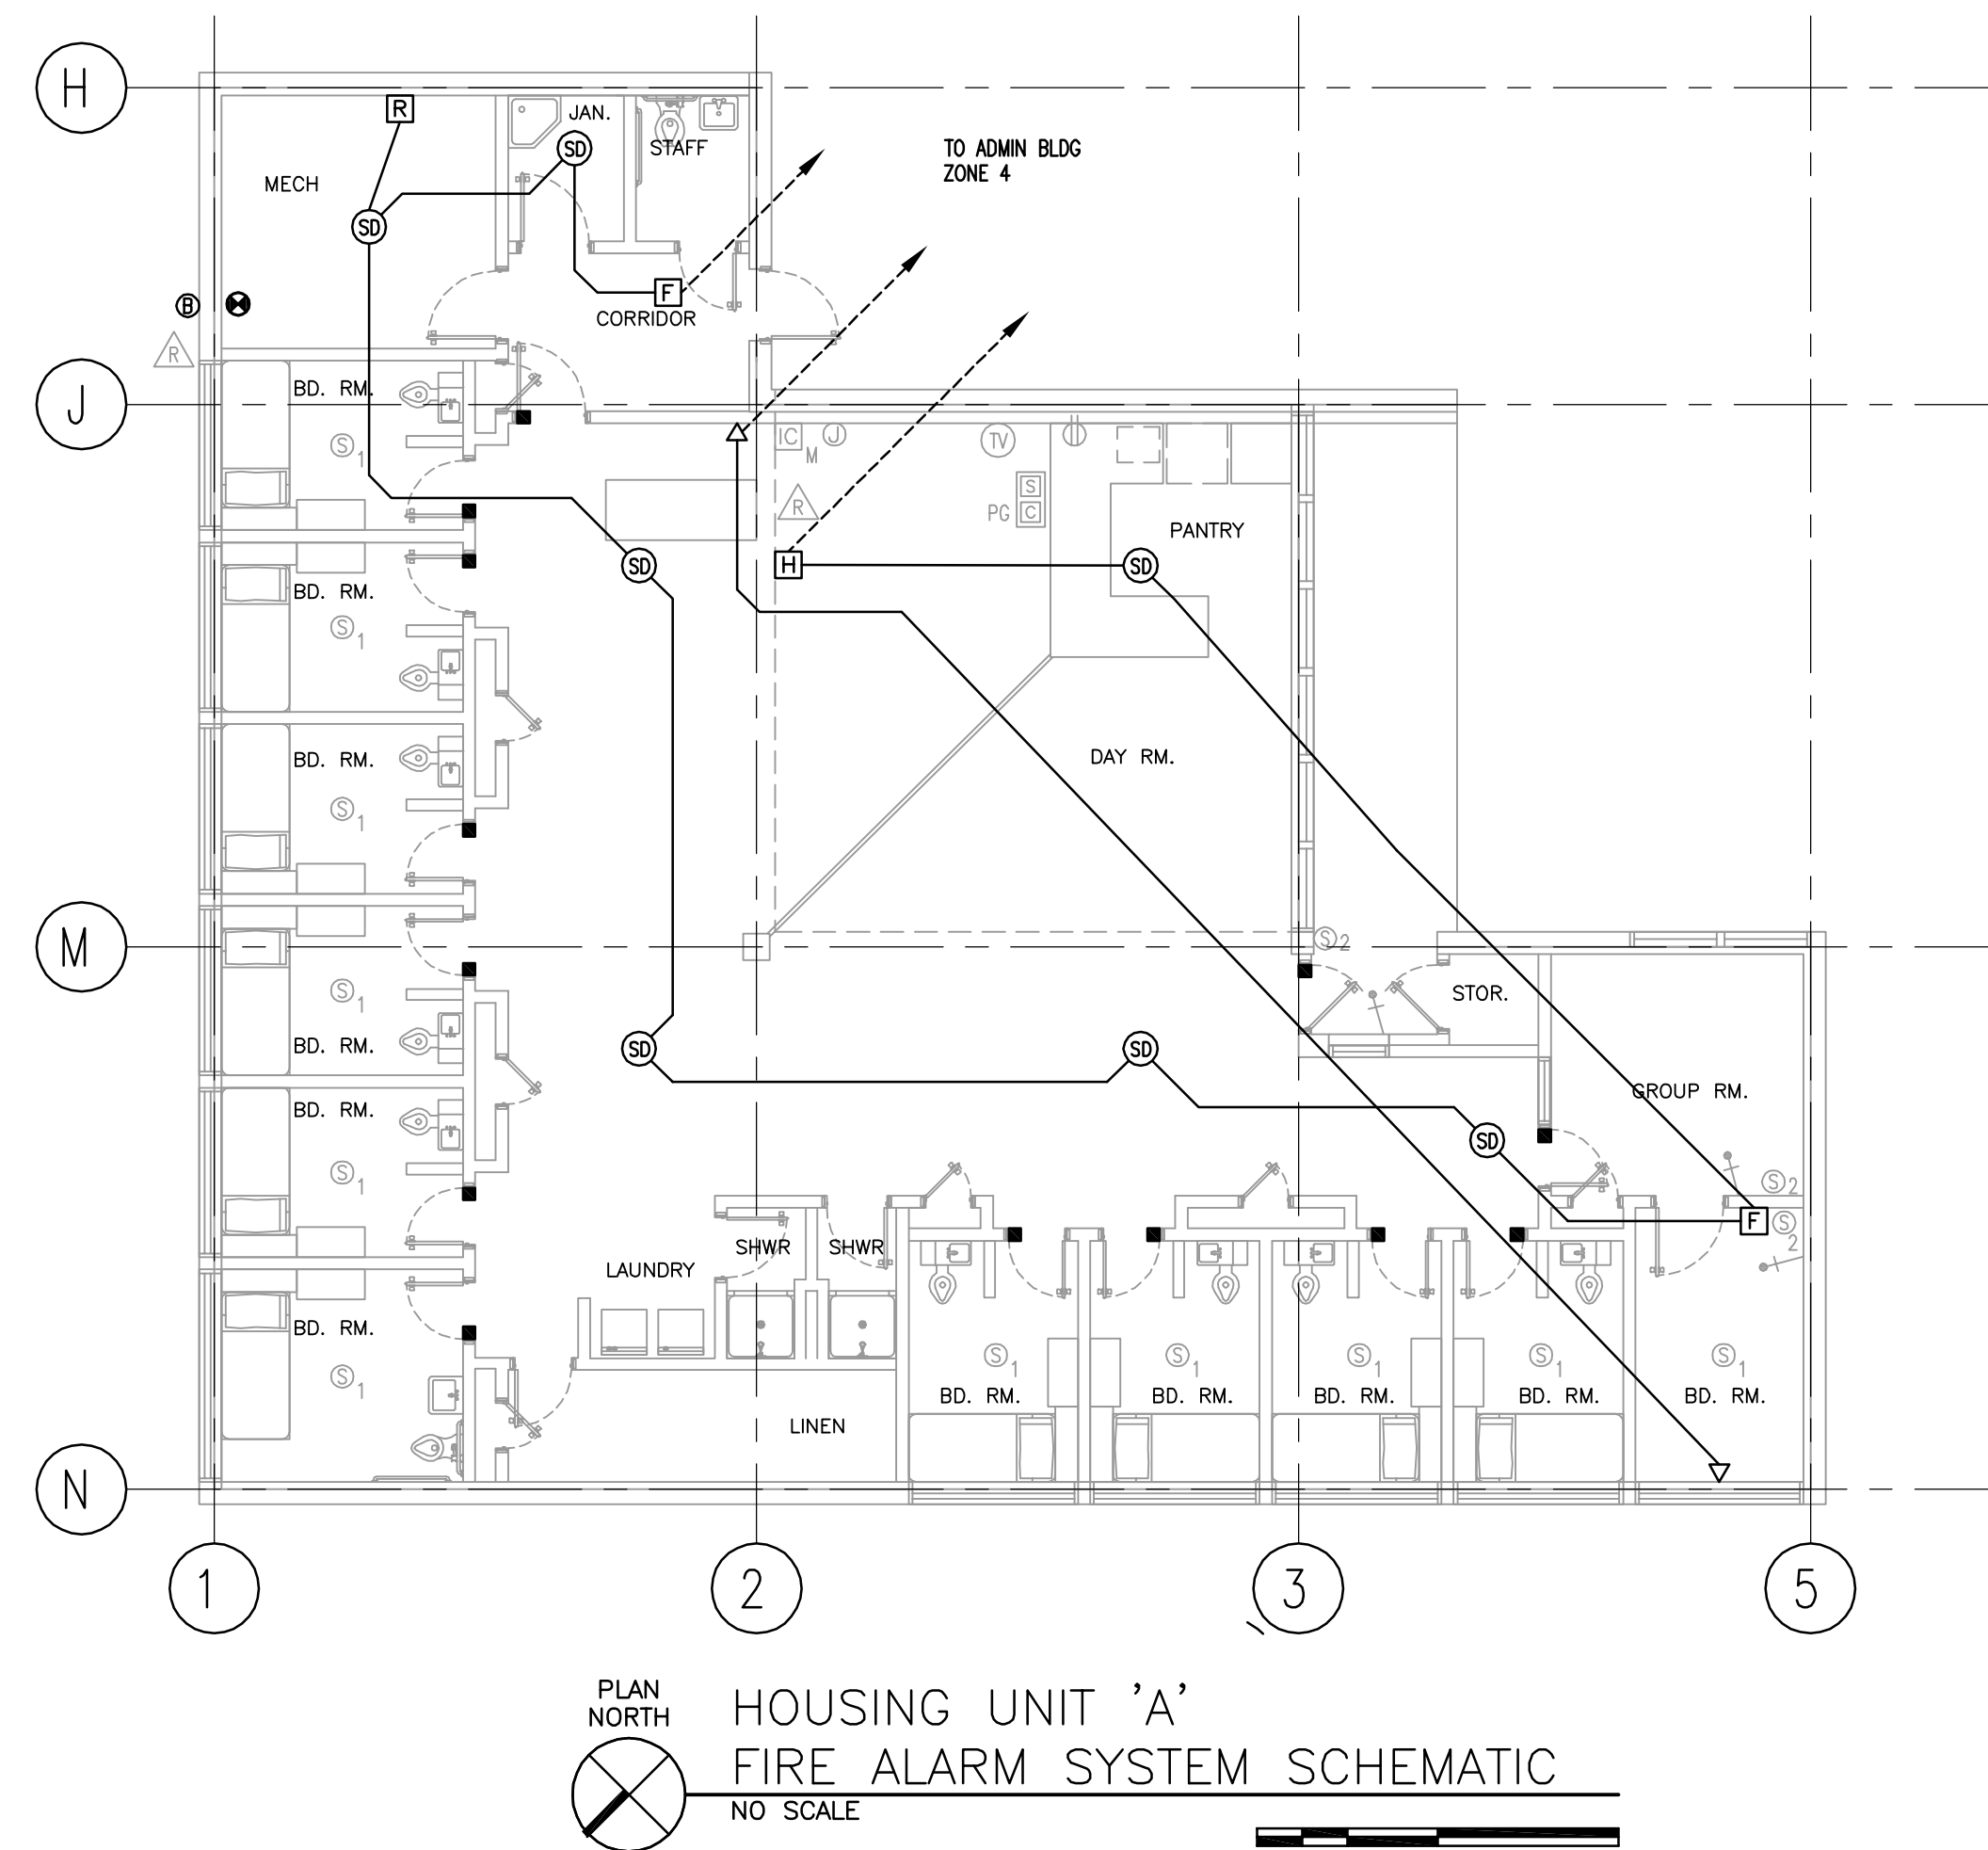



By: sharon Feb 22, 2006 - 10:20am  
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PLAN NORTH  
ADMINISTRATION BLDG.  
SYSTEMS PLAN - AREA A  
SCALE: 1/8" = 1'-0"
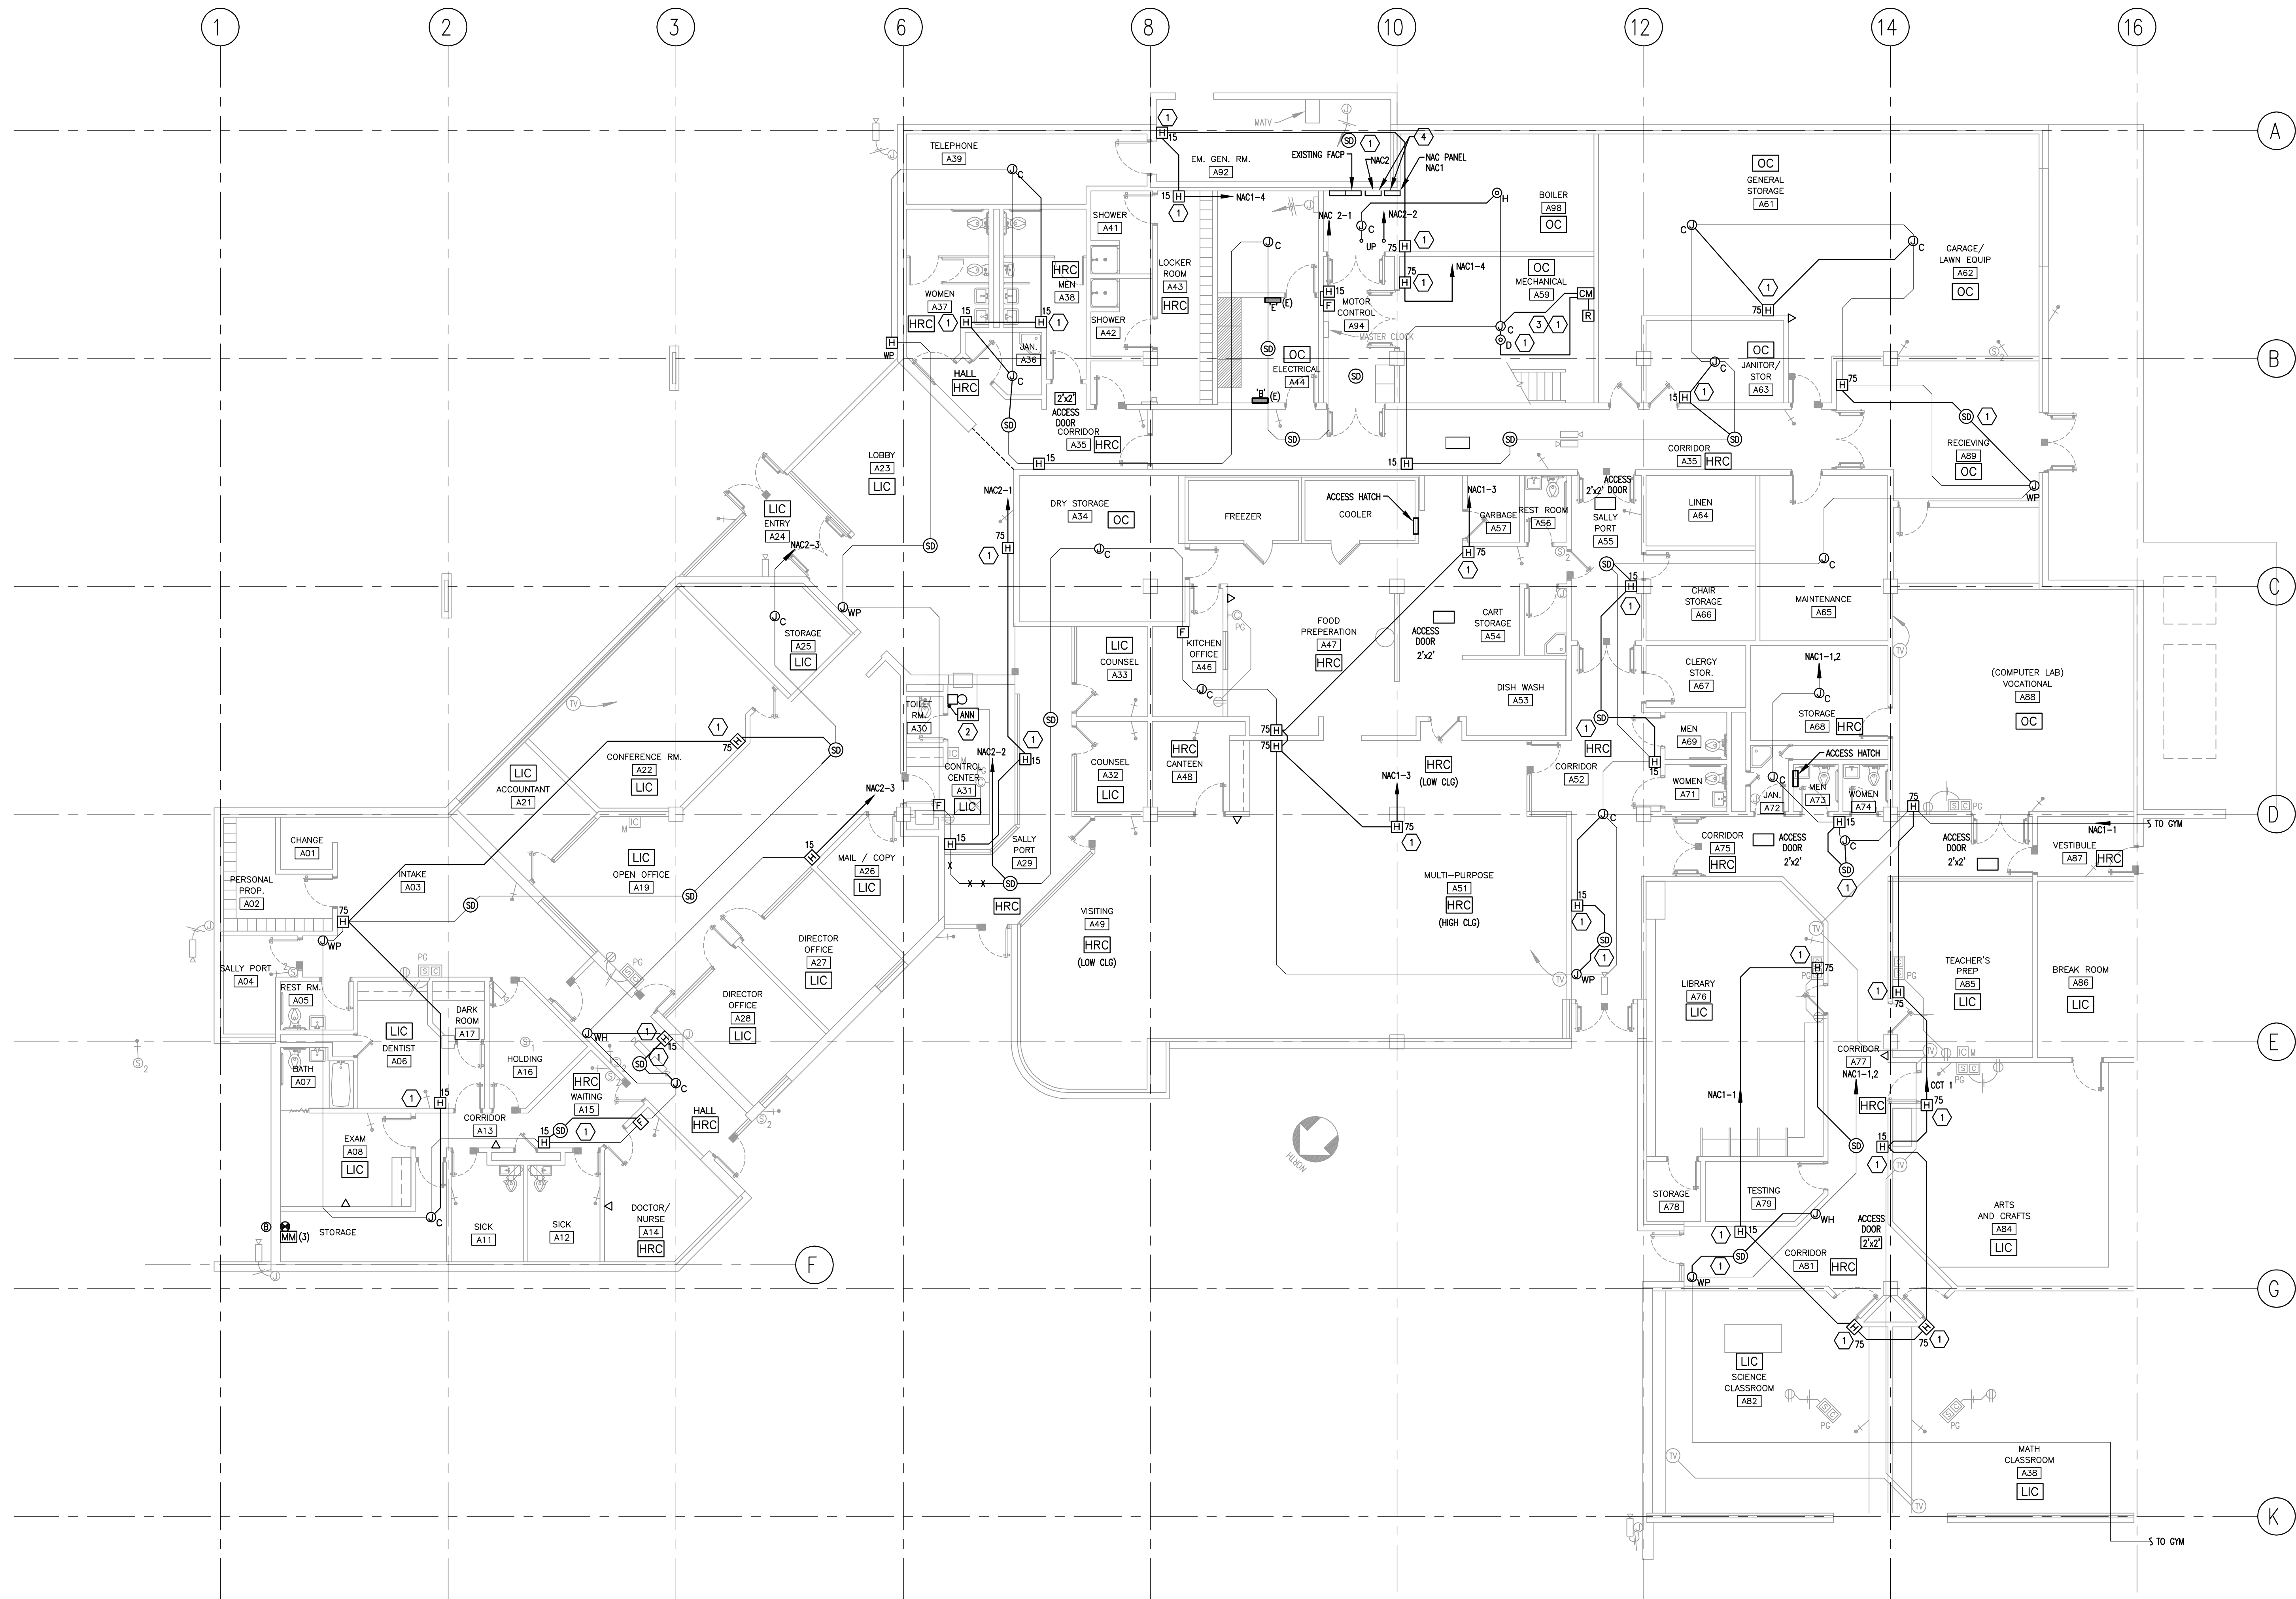
### LEGEND

- WP FA PULL STATION BOX-WALL
- WH FA HORN BOX-WALL
- C FA SMOKE DETECTOR BOX-CEILING
- OC OPEN CEILING WITH GYP BOARD FASTENED TO ROOF DECK
- HRC HARD CEILING (GYP BOARD, GLUE-ON TILE, ETC.)
- LIC LAY-IN CEILING

### GENERAL SHEET NOTES

1. NEW CONDUIT SHALL BE RUN CONCEALED WITHIN THE ACCESSIBLE CEILINGS AND PARTITION WALLS.
2. IN AREAS WITH NON-ACCESSIBLE CEILINGS OR MASONRY WALLS, NEW CONDUIT SHALL BE RUN SURFACE MOUNTED. THE CONTRACTOR SHALL PAINT ALL CONDUITS TO MATCH THE EXISTING WALL AND CEILING SURFACES.
3. AT ALL EXISTING DEVICE LOCATIONS THAT ARE NOT REUSED, PROVIDE BLANK COVER, PAINT TO MATCH EXISTING SURFACE.

### SHEET KEYNOTES


1. ADDITIONAL DEVICE ADDED COMPLETE WITH BOX, DEVICE, CONDUIT AND WIRE.
2. PROVIDE AN ADDRESSABLE REMOTE ANNUNCIATOR (READOUT AND AUDIBLE ALARM) TO REPLACE THE EXISTING DURESS INDICATING LIGHT PANEL.
3. PROVIDE CONTROL MODULE AND RELAYS AS REQUIRED FOR FAN SHUTDOWN, WITH CONDUIT AND WIRING CONNECTIONS TO FAN CONTROLS.
4. PROVIDE 120 VOLT POWER CIRCUITS TO NAC PANELS.

MARK	DATE	DESCRIPTION
△		

DATE: FEBRUARY 22, 2006  
PROJECT NO: 05339A  
DRAWN BY: BNA  
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SYSTEMS  
PLAN, AREA A

By: sharon, Feb 22, 2006 - 10:20am  
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LEGEND	
	FA PULL STATION BOX-WALL
	FA HORN BOX-WALL
	FA SMOKE DETECTOR BOX-CEILING
	OPEN CEILING WITH GYP BOARD FASTENED TO ROOF DECK
	HARD CEILING (GYP BOARD, GLUE-ON TILE, ETC.)
	LAY-IN CEILING

GENERAL NOTES	
1.	NEW CONDUIT SHALL BE RUN CONCEALED WITHIN THE ACCESSIBLE CEILINGS AND PARTITION WALLS.
2.	IN AREAS WITH NON-ACCESSIBLE CEILINGS OR MASONRY WALLS, NEW CONDUIT SHALL BE RUN SURFACE MOUNTED. THE CONTRACTOR SHALL PAINT ALL CONDUIT TO MATCH EXISTING WALL AND CEILING SURFACES.
3.	AT ALL EXISTING DEVICE LOCATIONS THAT ARE NOT REUSED, PROVIDE BLANK COVER, PAINT TO MATCH EXISTING SURFACE.

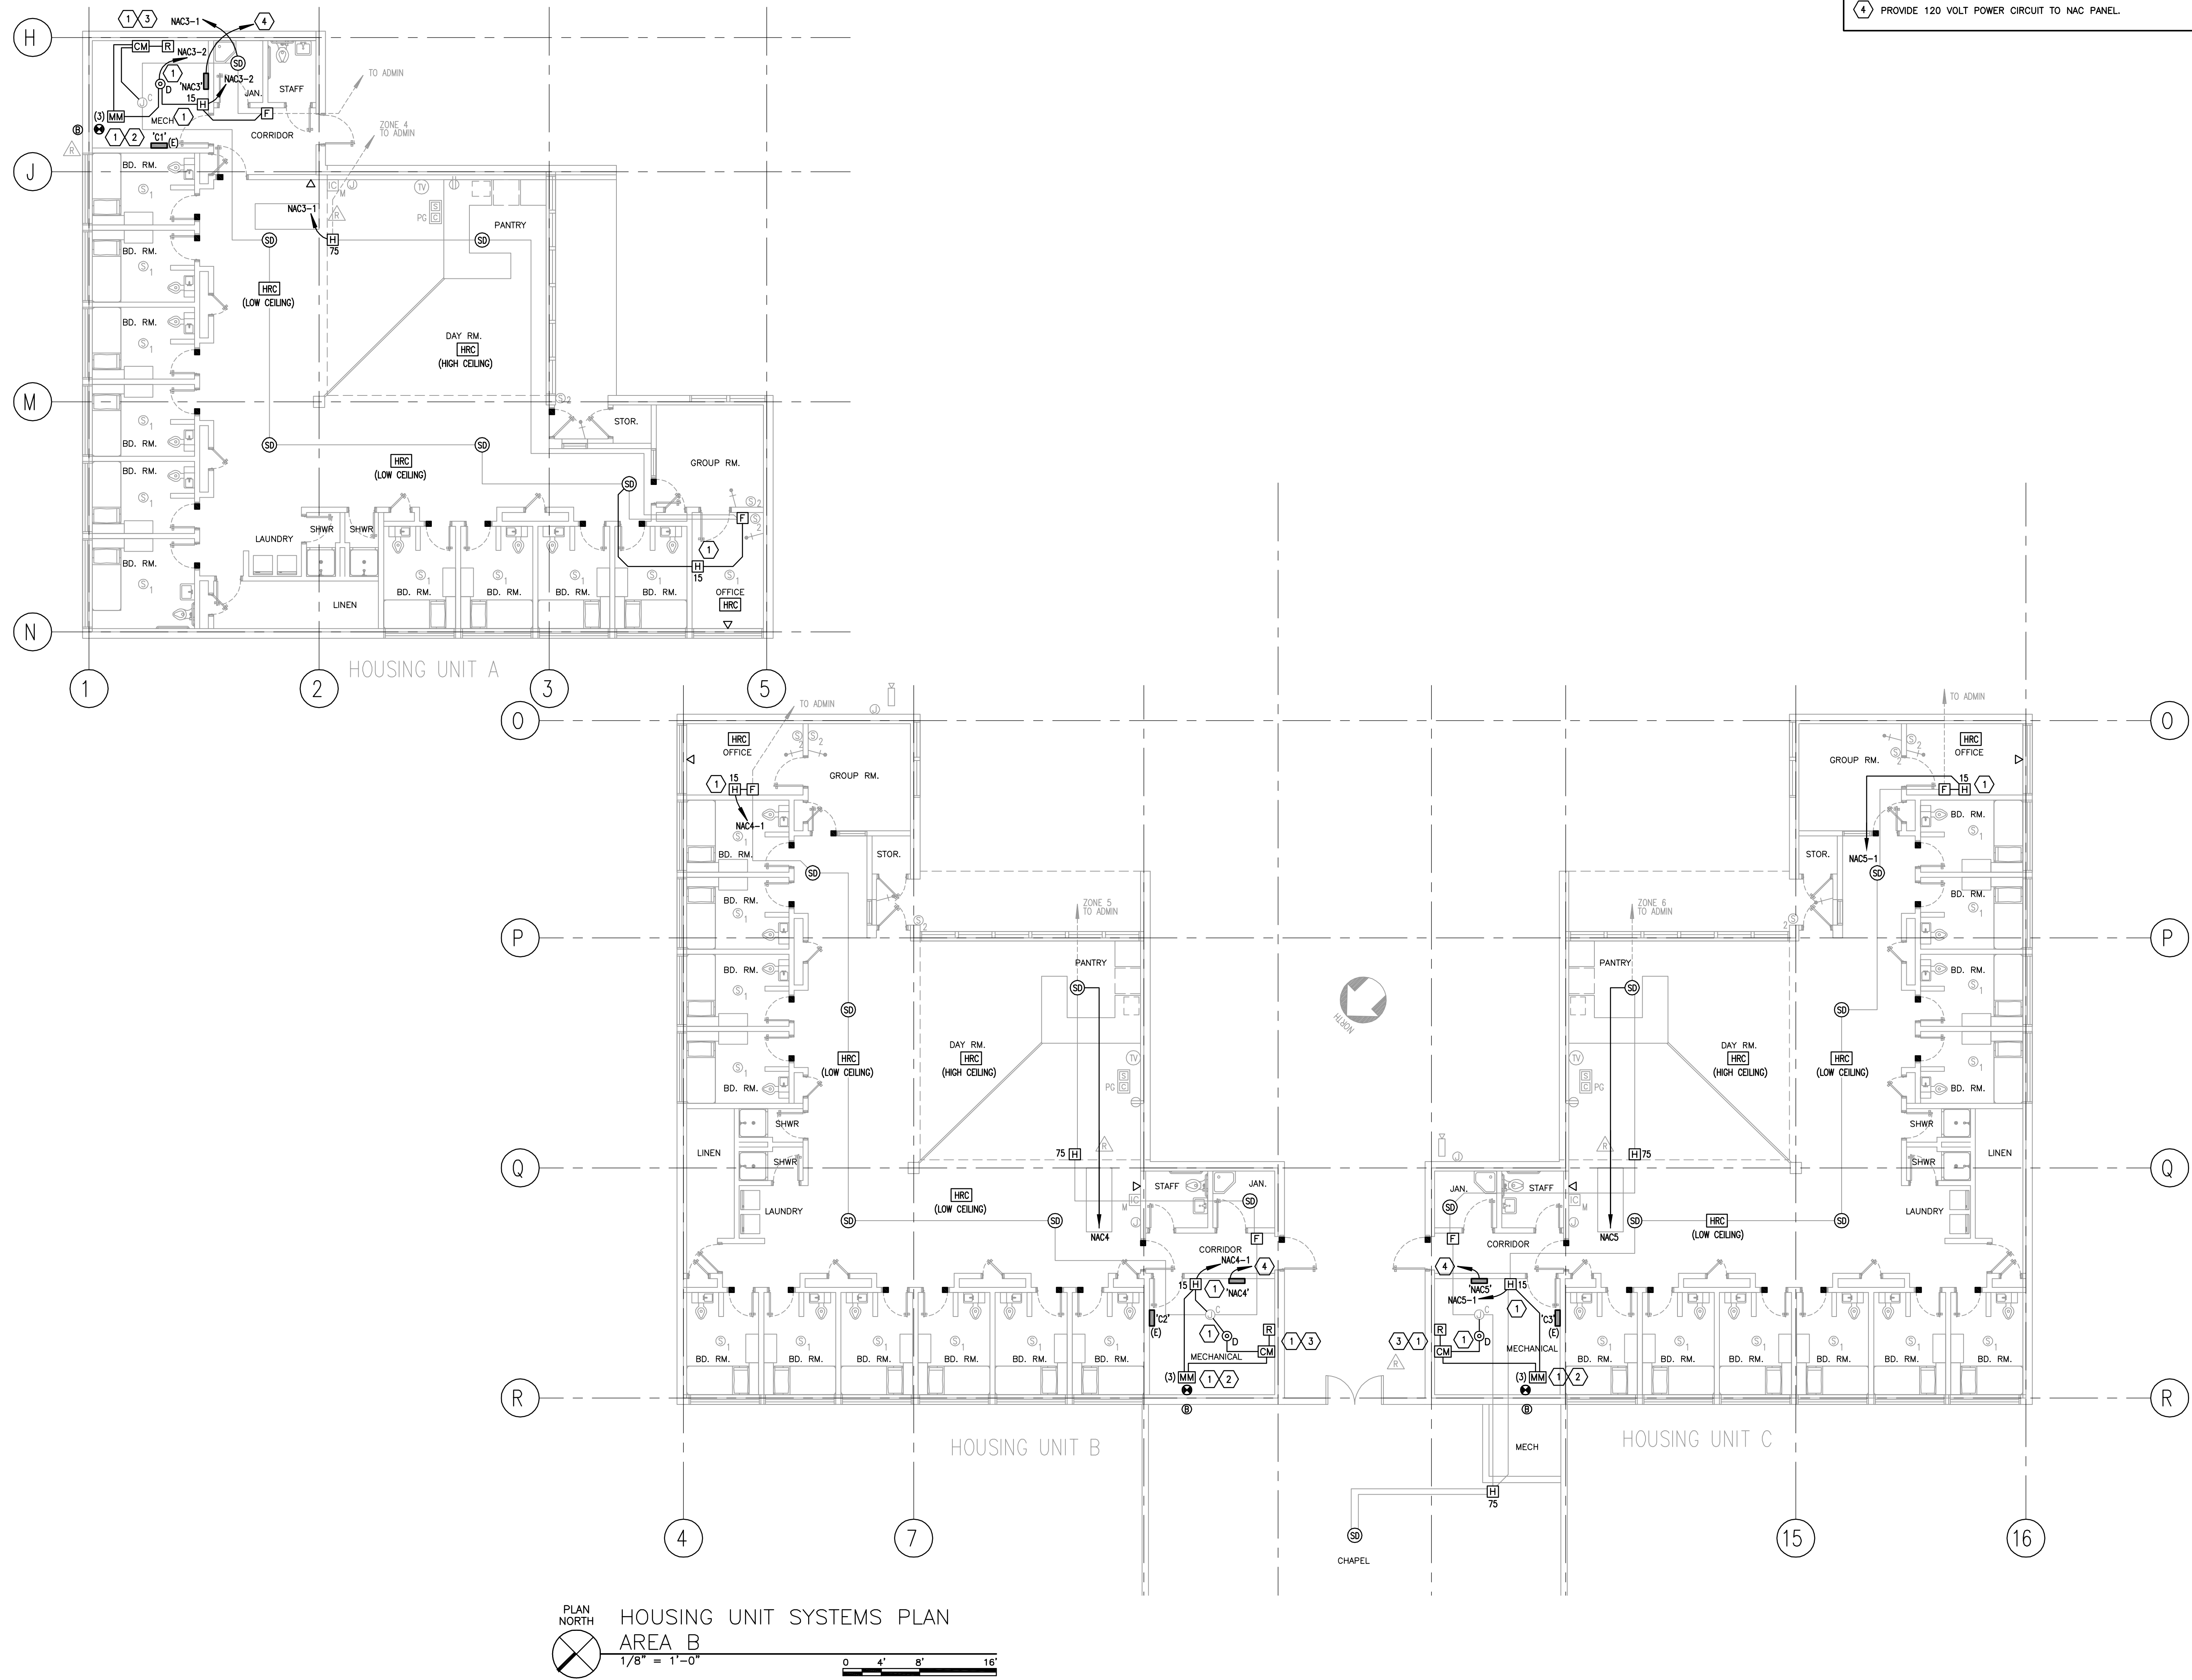SHEET KEYNOTES	
1	ADDITIONAL DEVICE ADDED COMPLETE WITH BOX, DEVICE, CONDUIT AND WIRE.
2	PROVIDE MONITOR MODULES WITH CONDUIT AND WIRE CONNECTIONS TO FIRE SPRINKLER VALVE TAMPER AND FLOW.
3	PROVIDE CONTROL MODULE AND RELAYS AS REQUIRED FOR FAN SHUTDOWN, WITH CONDUIT AND WIRE CONNECTIONS TO FAN CONTROLS.
4	PROVIDE 120 VOLT POWER CIRCUIT TO NAC PANEL.

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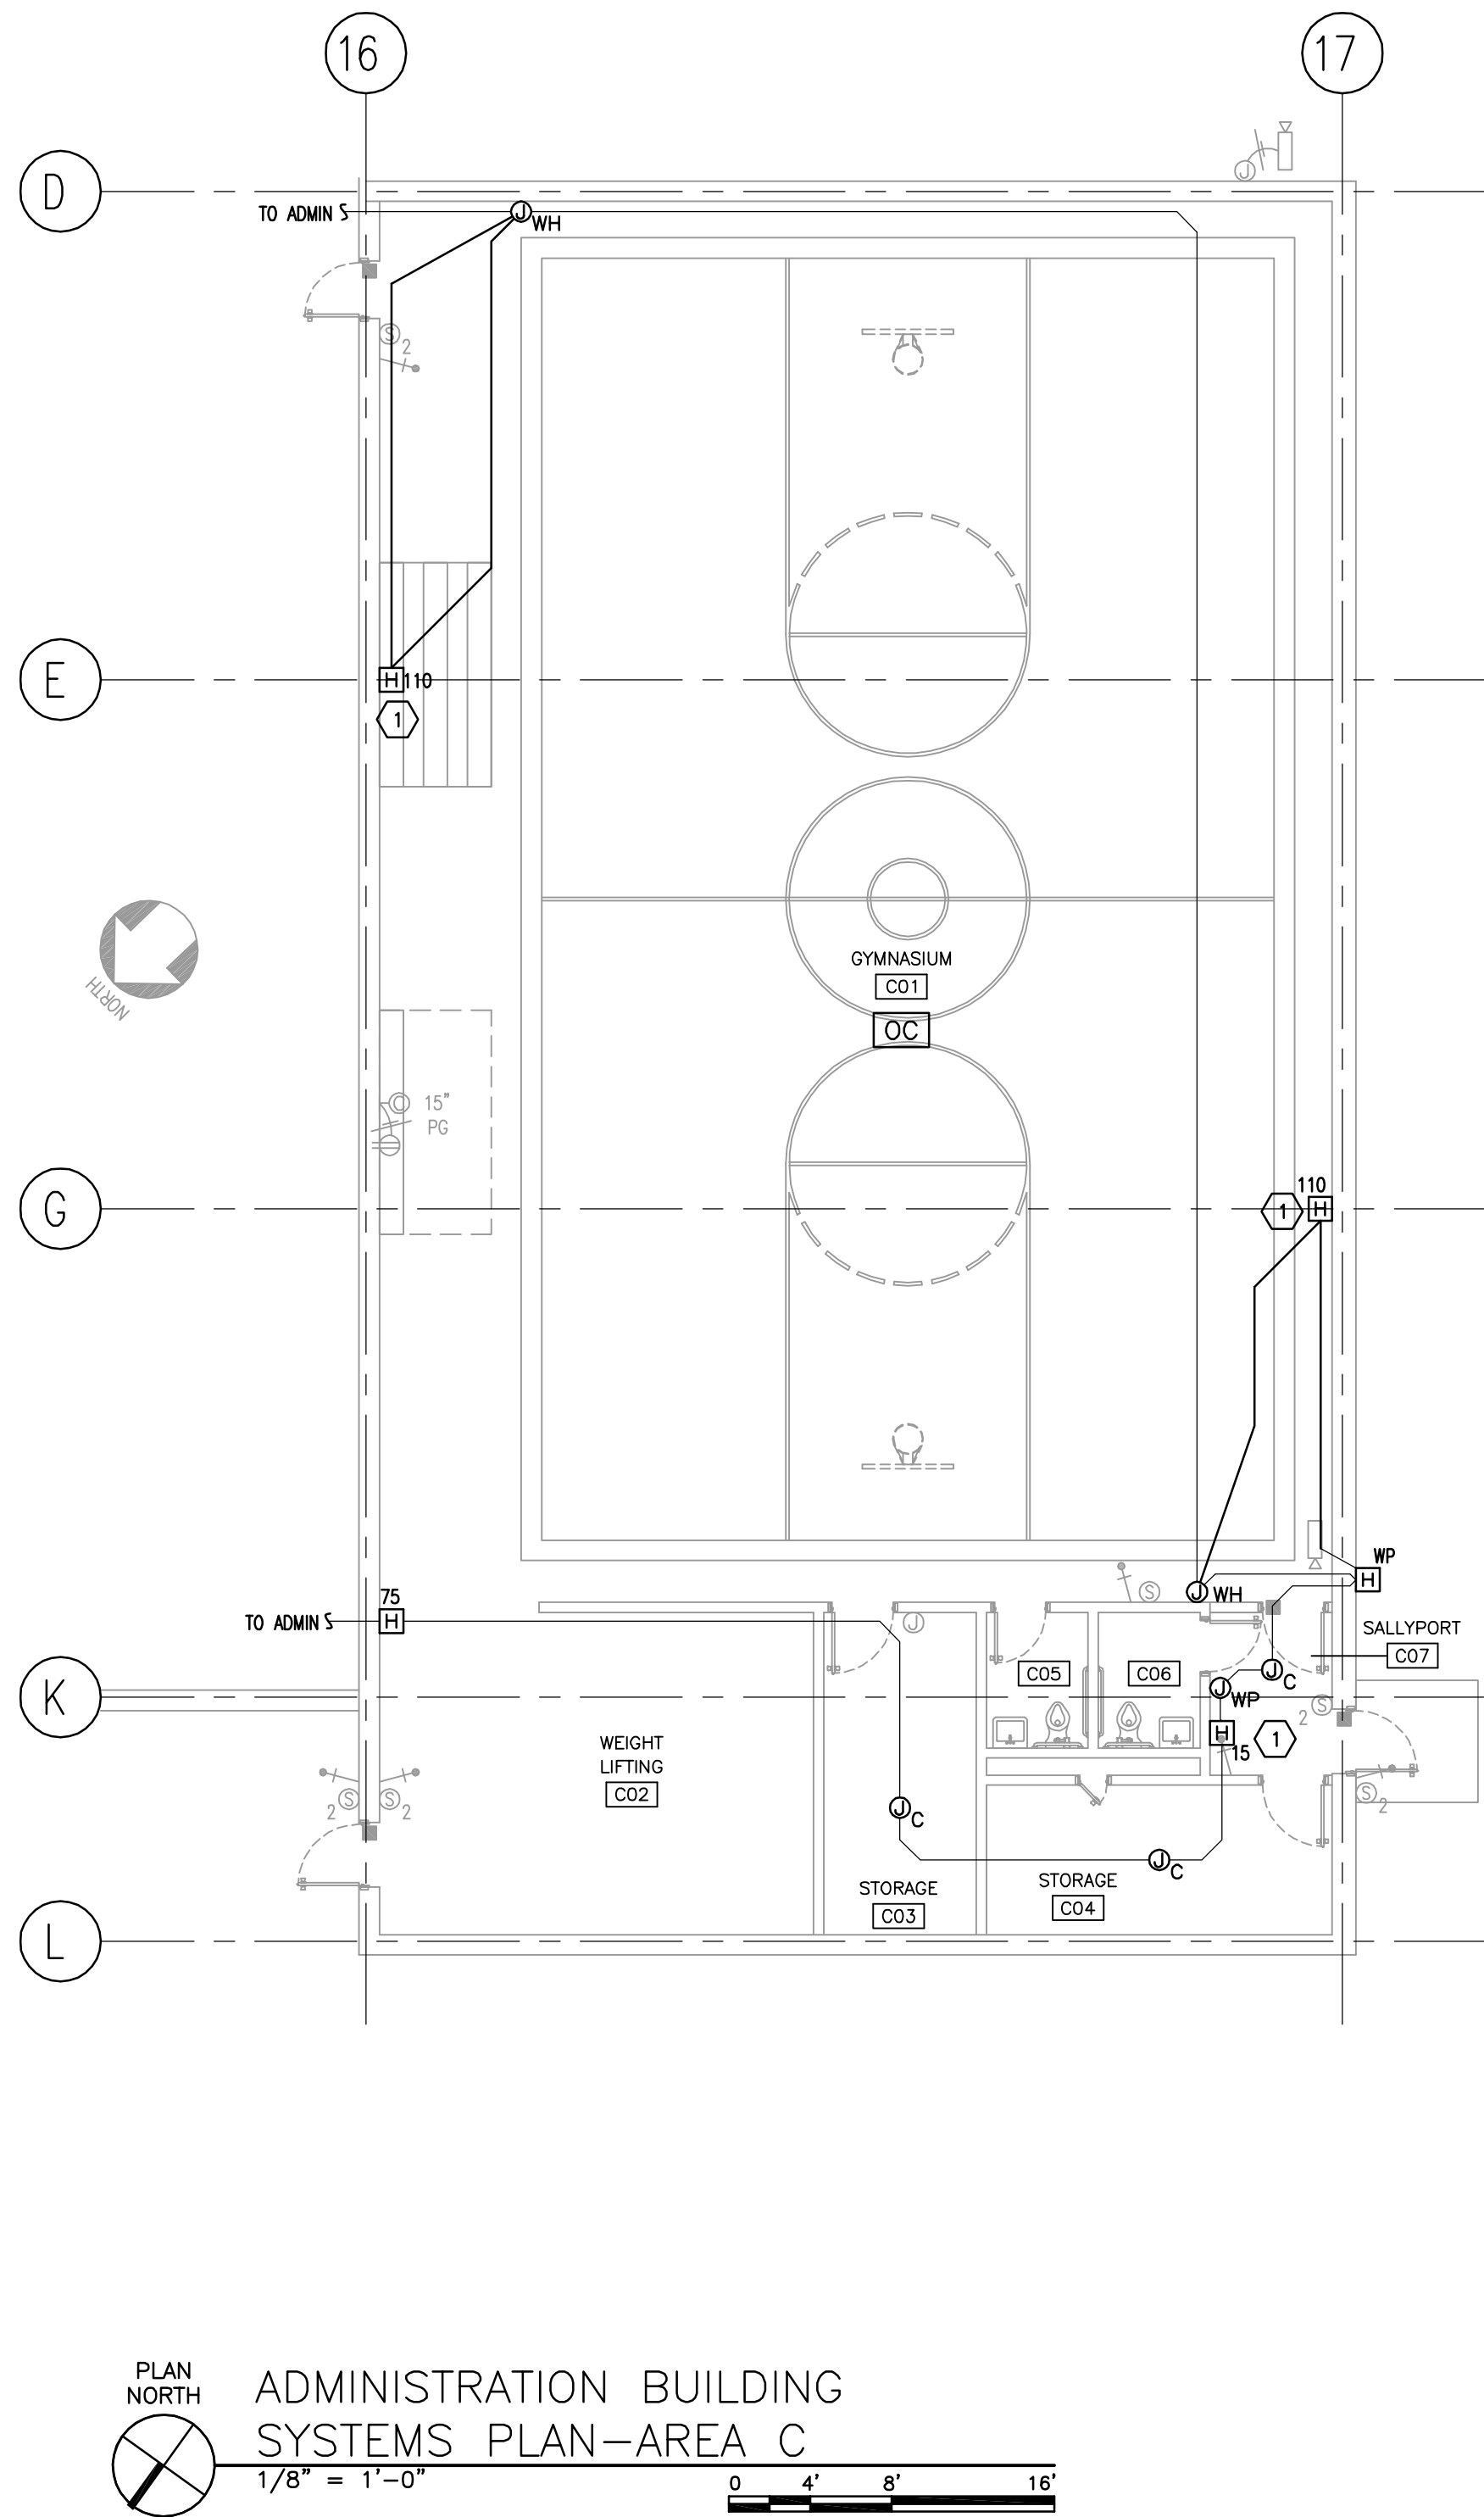
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DEPARTMENT OF SOCIAL SERVICES  
ADDRESS

ADDENDUM/CLARIFICATION/REVISION		
MARK	DATE	DESCRIPTION

DATE:	FEBRUARY 22, 2006
PROJECT NO:	05339A
DRAWN BY:	BNA
CHK'D BY:	GM

SYSTEMS  
PLAN, AREA B

E4-2



## LEGEND

WP	FA PULL STATION BOX-WALL
WH	FA HORN BOX-WALL
C	FA SMOKE DETECTOR BOX-CEILING
OC	OPEN CEILING WITH GYP BOARD FASTENED TO ROOF DECK
HRC	HARD CEILING (GYP BOARD, GLUE-ON TILE, ETC.)
LUC	LAY-IN CEILING

## GENERAL SHEET NOTES

1. NEW CONDUIT SHALL BE RUN CONCEALED WITHIN THE ACCESSIBLE CEILINGS AND PARTITION WALLS.
2. IN AREAS WITH NON-ACCESSIBLE CEILINGS OR MASONRY WALLS, NEW CONDUIT SHALL BE RUN SURFACE MOUNTED. THE CONTRACTOR SHALL PAINT ALL CONDUIT TO MATCH THE EXISTING WALL AND CEILING SURFACES.
3. AT ALL EXISTING DEVICE LOCATIONS THAT ARE NOT REUSED, PROVIDE BLANK COVER, PAINT TO MATCH EXISTING SURFACE.


## SHEET KEYNOTES

- ① ADDITIONAL DEVICE ADDED COMPLETE WITH BOX, DEVICE, CONDUIT AND WIRE.

MARK	DATE	DESCRIPTION
△	.	

DATE:	FEBRUARY 22, 2006
PROJECT NO:	05339A
DRAWN BY:	BNA
CHK'D BY:	GM

SYSTEMS  
PLAN, AREA C

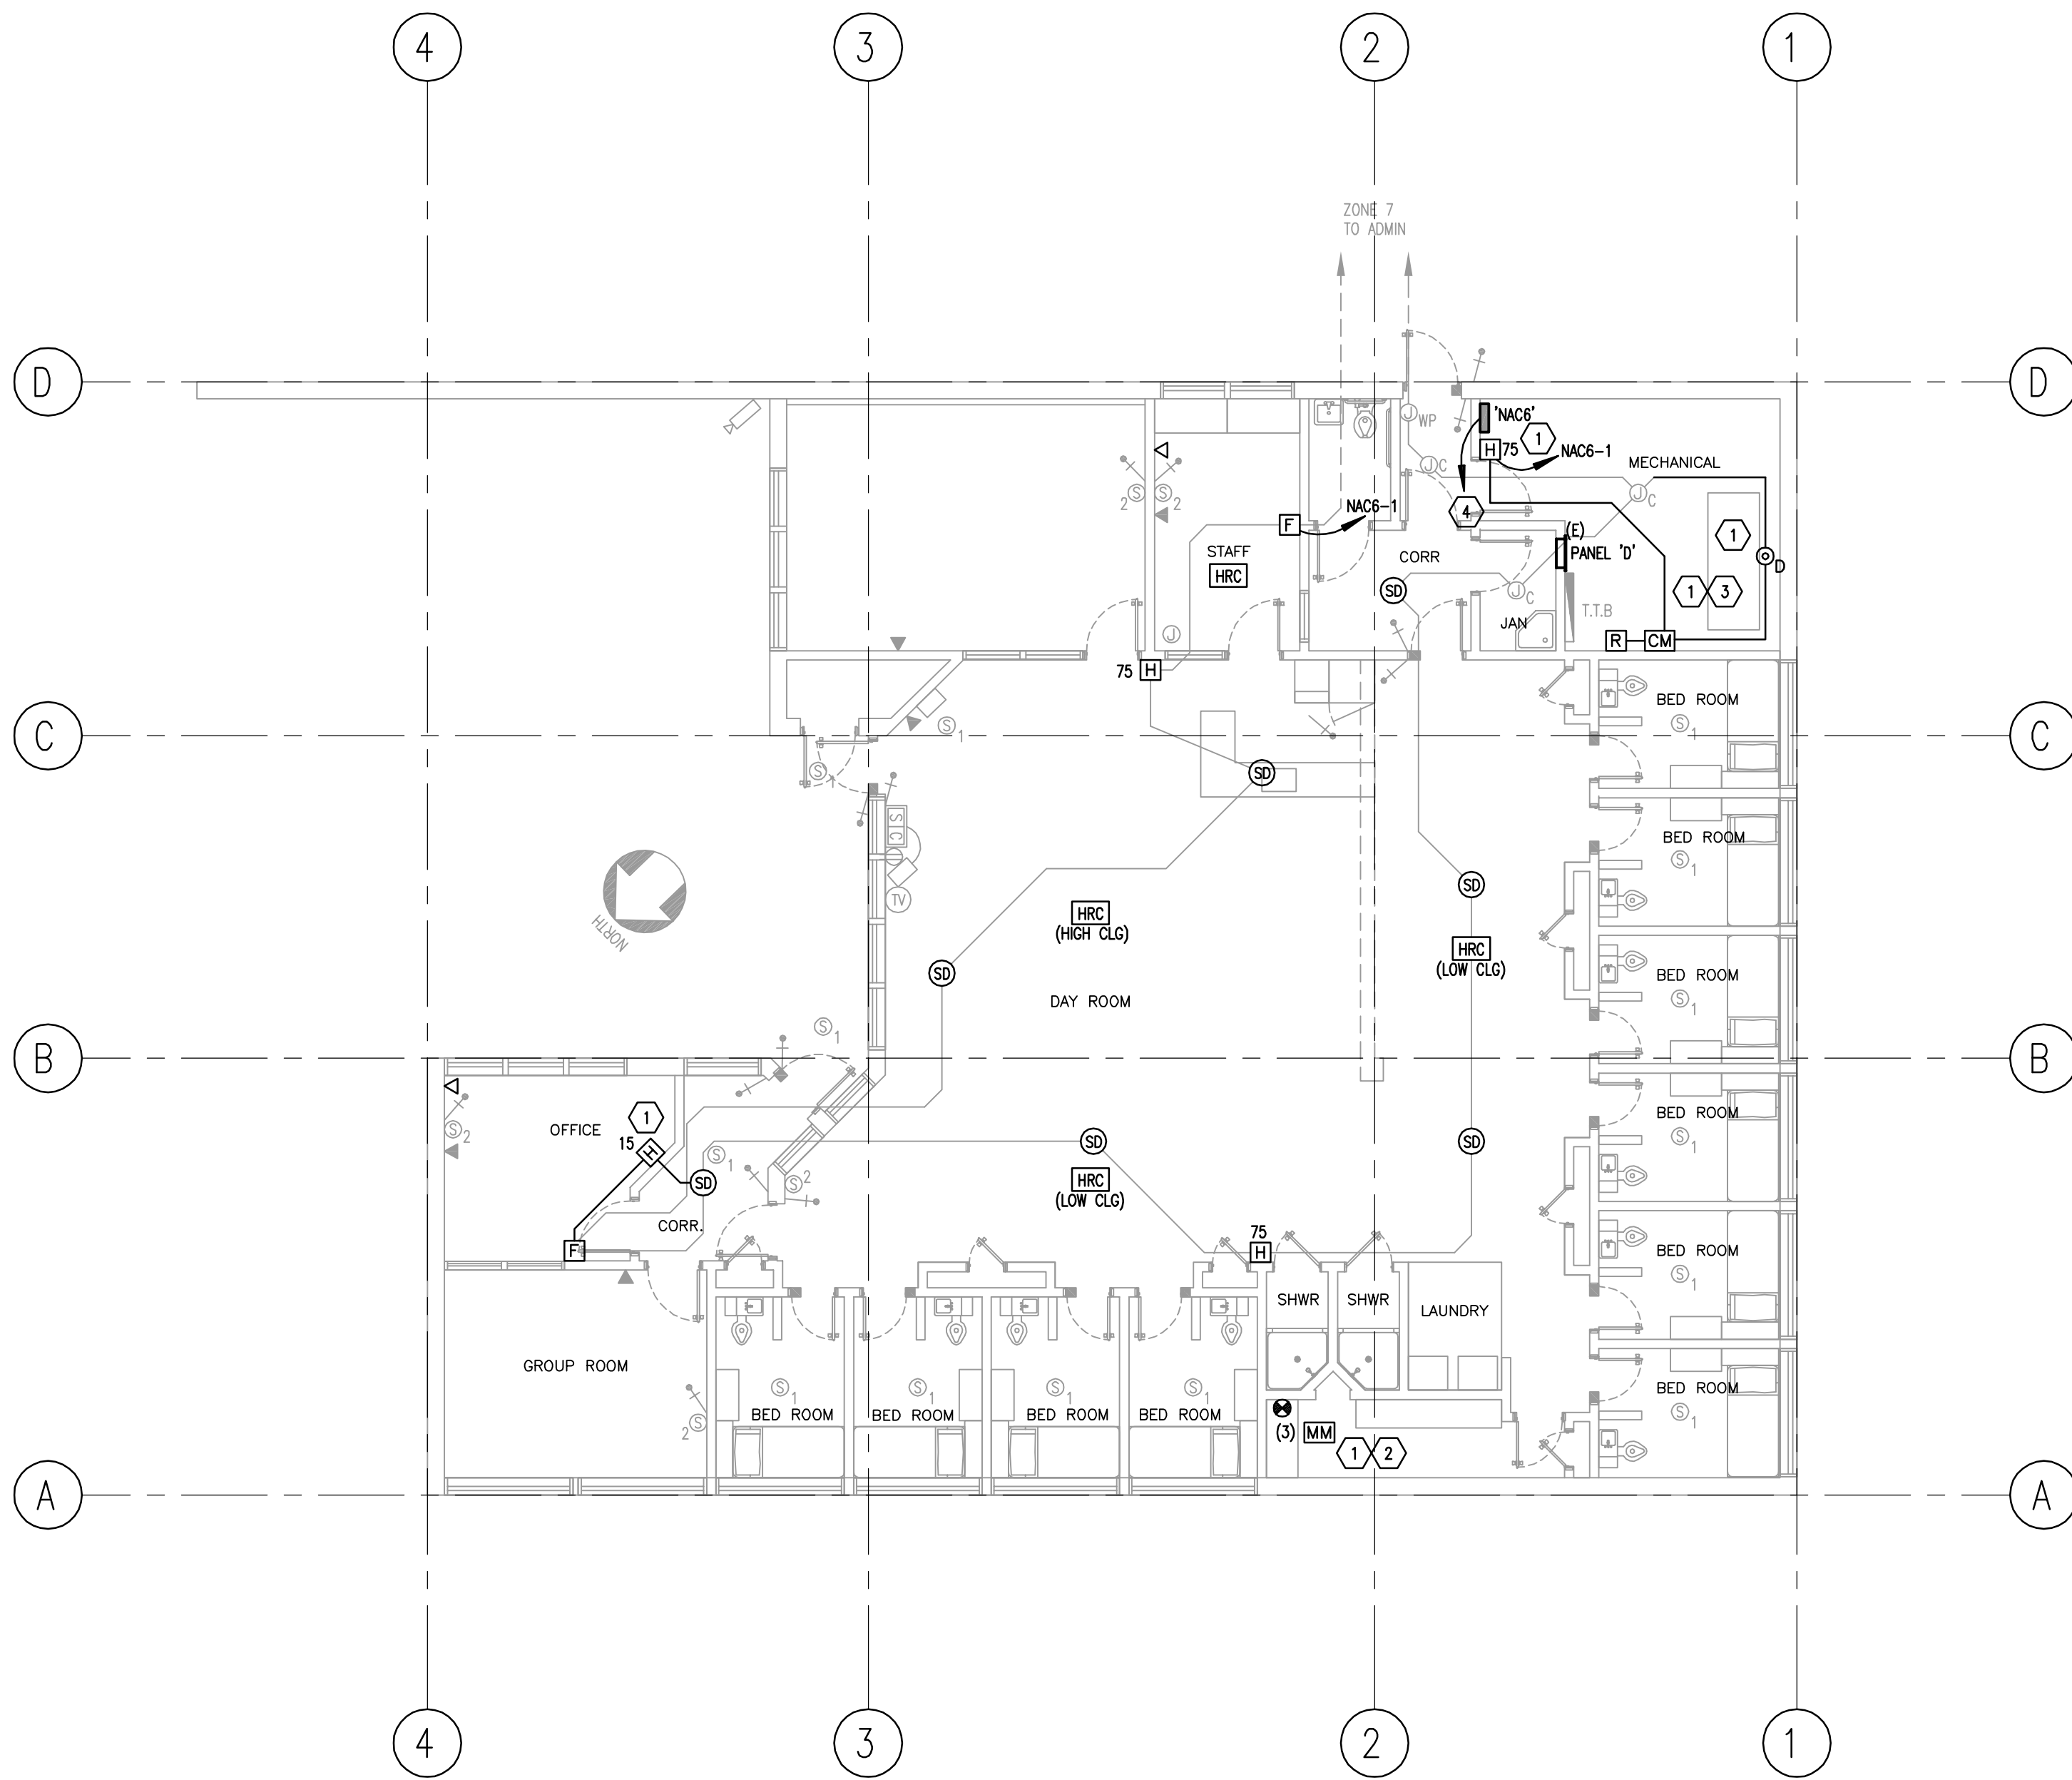

PLAN NORTH  
HOUSING UNIT D-SYSTEMS PLAN  
SCALE: 1/8" = 1'-0"  
0 4' 8' 16'

### LEGEND

- WP FA PULL STATION BOX-WALL
- WH FA HORN BOX-WALL
- C FA SMOKE DETECTOR BOX-CEILING
- OC OPEN CEILING WITH GYP BOARD FASTENED TO ROOF DECK
- HRC HARD CEILING (GYP BOARD, GLUE-ON TILE, ETC.)
- LIC LAY-IN CEILING

### GENERAL SHEET NOTES

1. NEW CONDUIT SHALL BE RUN CONCEALED WITHIN THE ACCESSIBLE CEILINGS AND PARTITION WALLS.
2. IN AREAS WITH NON-ACCESSIBLE CEILINGS OR MASONRY WALLS, NEW CONDUIT SHALL BE RUN SURFACE MOUNTED. THE CONTRACTOR SHALL PAINT ALL CONDUIT TO MATCH THE EXISTING WALL AND CEILING SURFACES.
3. AT ALL EXISTING DEVICE LOCATIONS THAT ARE NOT REUSED, PROVIDE BLANK COVER, PAINT TO MATCH EXISTING SURFACE.

### SHEET KEYNOTES

1. ADDITIONAL DEVICE ADDED COMPLETE WITH BOX, DEVICE, CONDUIT, AND WIRE.
2. PROVIDE MONITOR MODULES, WITH CONDUIT AND WIRE CONNECTIONS TO FIRE SPRINKLER VALVE TAMPER AND FLOW.
3. PROVIDE CONTROL MODULE AND RELAYS AS REQUIRED FOR FAN SHUTDOWN, WITH CONDUIT AND WIRE CONNECTIONS TO FAN CONTROLS.
4. PROVIDE 120 VOLT POWER CIRCUIT TO NAC PANEL.

ADDENDUM/CLARIFICATION/REVISION		
MARK	DATE	DESCRIPTION
△	.	

DATE: FEBRUARY 22, 2006  
PROJECT NO: 05339A  
DRAWN BY: BNA  
CHK'D BY: GM

SYSTEMS  
PLAN,  
HOUSING  
UNIT D